


# GENERAL PROJECT NOTES

- A. THIS WORK SHALL COMPLY WITH ALL 2013 CBC, CMC, CPC, CEC, CALIFORNIA ENERGY CODE, AND CALIFORNIA RESIDENTIAL CODE, AND ALL OTHER REGULATIONS AS AMENDED TO DATES APPROVED BY THE CITY OF SARATOGA.
- B. WRITTEN DIMENSIONS ON THESE DRAWINGS SHALL HAVE PRECEDENCE OVER SCALED DIMENSIONS. WRITTEN DIMENSIONS ARE APPROXIMATE AND MUST BE VERIFIED BY CONTRACTOR. CONTRACTOR SHALL VERIFY, AND BE RESPONSIBLE FOR, ALL EXISTING CONDITIONS AND DIMENSIONS PRIOR TO, AND DURING, ALL PHASES OF WORK.
- C. IF THE CONTRACTOR FINDS ANY LACK OF INFORMATION, DISCREPANCY, AND/OR OMISSIONS IN THESE DRAWINGS, OR IF THE CONTRACTOR IS UNCLEAR AS TO THE DRAWINGS' MEANING AND/OR INTENT, THE CONTRACTOR SHALL CONTACT THE ARCHITECT AT ONCE FOR INTERPRETATION AND/OR CLARIFICATION BEFORE PROCEEDING WITH THAT PORTION OF THE WORK. IF ANY SUBCONTRACTOR FINDS ANY LACK OF INFORMATION, DISCREPANCY, AND/OR OMISSIONS IN THESE DRAWINGS, OR IF ANY SUBCONTRACTOR IS UNCLEAR AS TO THE DRAWINGS' MEANING AND/OR INTENT, THAT SUBCONTRACTOR SHALL CONTACT THE GENERAL CONTRACTOR, WHO SHALL THEN CONTACT THE ARCHITECT AT ONCE FOR INTERPRETATION AND/OR CLARIFICATION BEFORE DIRECTING THE SUBCONTRACTOR TO PROCEED WITH THAT PORTION OF THE WORK.
- D. NO CHANGES, MODIFICATIONS, OR DEVIATIONS SHALL BE MADE TO AND/OR FROM THE DRAWINGS AND/OR SPECIFICATIONS WITHOUT FIRST SECURING WRITTEN PERMISSION FROM THE ARCHITECT AND THE OWNER.
- E. ALL MATERIALS USED SHALL BE EQUAL TO, OR EXCEED, ALL APPLICABLE STATE AND LOCAL CODES AND REQUIREMENTS.
- F. THE CONTRACTOR SHALL PROMPTLY AND LEGALLY REMOVE ALL ACCUMULATED DEBRIS DAILY. SHALL PROTECT ALL EXPOSED PORTIONS OF THE WORK FROM WEATHER ELEMENTS, SHALL AVOID OVER-LOADING THE STRUCTURE WITH CONSTRUCTION MATERIALS, AND SHALL SECURELY STORE ALL ITEMS TO BE USED FOR AND IN THE CONSTRUCTION OF THE WORK.
- G. THE CONTRACTOR SHALL MAINTAIN, KEEP IN SERVICE, AND PROTECT AGAINST DAMAGE, ALL EXISTING UTILITIES AND CITY SERVICES DURING CONSTRUCTION.
- H. THE CONTRACTOR SHALL VERIFY THE LOCATION OF ALL EXISTING UNDERGROUND UTILITIES PRIOR TO EXCAVATION.
- I. ALL ELECTRICAL CALCULATIONS AND WIRE SIZES SHALL BE PROVIDED BY A CALIFORNIA-LICENSED ELECTRICAL CONTRACTOR. RECEPTACLE, SWITCH, FIXTURE, AND EQUIPMENT LOCATIONS SHALL BE FOUND ON THE SITE PLAN AND PROPOSED FLOOR PLANS WITHIN THESE DRAWINGS. THE CONTRACTOR SHALL VERIFY THE LOCATION, FIXTURE TYPES, AND EQUIPMENT WITH THE OWNER PRIOR TO PURCHASE AND INSTALLATION.
- J. THE CONTRACTOR SHALL TAKE ALL NECESSARY PRECAUTIONARY MEASURES TO PROTECT THE PUBLIC, AND ADJACENT PROPERTIES FROM DAMAGE THROUGHOUT CONSTRUCTION.
- K. ALL PRODUCTS LISTED IN THESE DRAWINGS BY ICBO/NER NUMBER SHALL BE INSTALLED PER THE REPORT AND MANUFACTURER'S WRITTEN INSTRUCTIONS. PRODUCT SUBSTITUTION FOR PRODUCTS LISTED SHALL ALSO HAVE AN ICBO/NER-APPROVED WRITTEN EVALUATION REPORT AND BE APPROVED AND LISTED BY OTHER NATIONALLY-RECOGNIZED TESTING AGENCIES.
- L. SEE STRUCTURAL SHEETS FOR PROJECT CONSTRUCTION NOTES AND DETAILS.
- M. SEE ATTACHED TITLE 24 FORMS AND/OR CALCULATIONS FOR PROJECT ENERGY EFFICIENCY REQUIREMENTS.

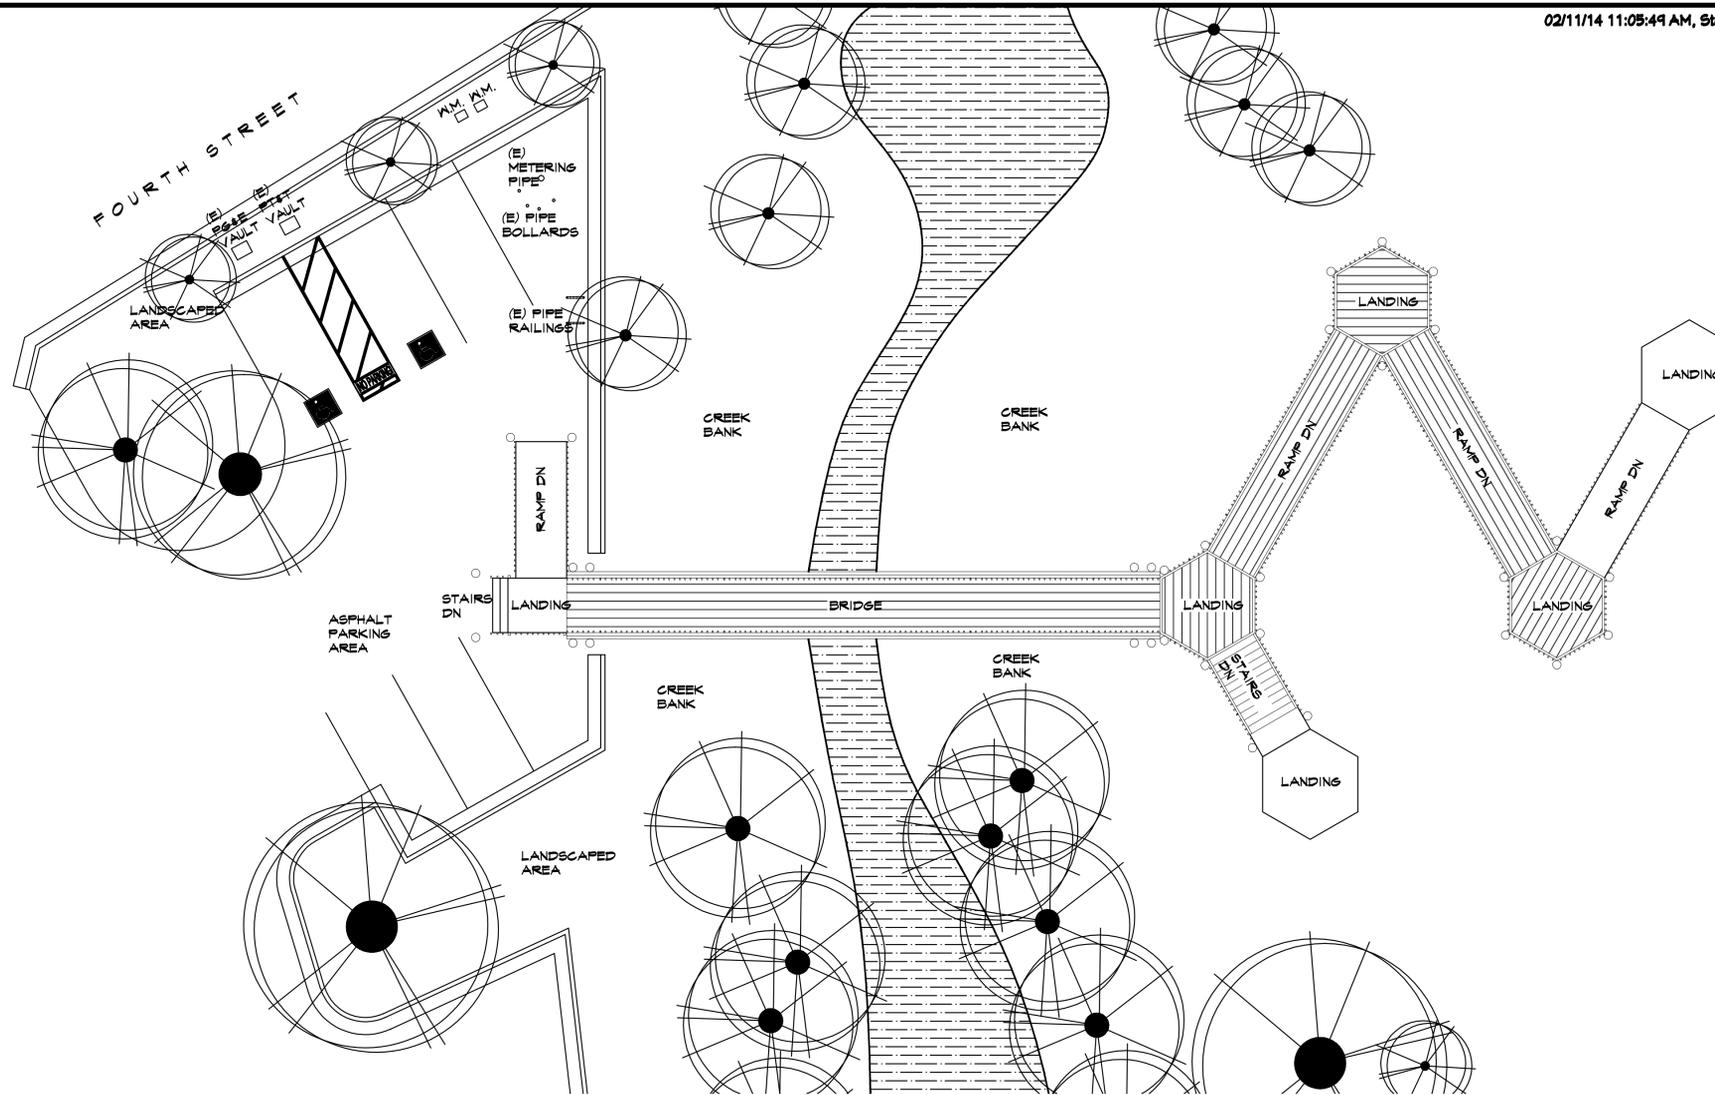

02/11/14 11:05:49 AM, Steve Benzing - Architect

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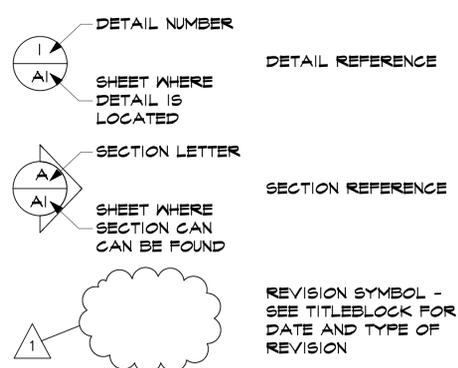
## SITE PLAN & GENERAL NOTES

Renovations to  
Winwood Park  
Pedestrian Bridge  
Saratoga, Ca  
for:  
City of Saratoga  
13777 Fruitvale Ave.  
Saratoga, Ca

## SCOPE OF WORK

REMOVE EXISTING WOOD WALKING DECK, STAIR TREADS & RISERS AND MISCELLANEOUS SUPPORTS, WOOD RAILINGS AND METAL HANDRAILS AND ALL ASSOCIATED SUPPORT AND ATTACHMENT/ FASTENERS, AND LIGHT FIXTURES, AS REQUIRED TO FACILITATE NEW WORK. PROVIDE AND INSTALL NEW WOOD WALKING DECK, STAIR TREADS & RISERS AND MISCELLANEOUS SUPPORTS, WOOD RAILINGS AND METAL HANDRAILS AND ALL ASSOCIATED SUPPORT AND ATTACHMENT/ FASTENERS, AND LIGHT FIXTURES, AS SHOWN AND NOTED IN THE CONSTRUCTION DOCUMENTS FOR THIS PROJECT.

## SYMBOL LEGEND



## SHEET INDEX

- A1 - SITE PLAN & GENERAL NOTES
- A2 - CONSTRUCTION STAGING PLAN
- A3 - OVERALL EXISTING BRIDGE PLAN & DEMOLITION SECTIONS
- A4 - EXISTING / DEMOLITION BRIDGE PLANS
- A5 - OVERALL PROPOSED BRIDGE PLAN & DECK DETAILS
- A6 - PROPOSED BRIDGE PLANS
- A7 - SECTIONS & ELEVATIONS
- A8 - SECTIONS & ELEVATIONS
- A9 - SECTIONS & ELEVATIONS
- A10 - DETAILS
- E1 - ELECTRICAL PLAN
- E2 - ELECTRICAL DETAILS

## ABBREVIATIONS

- CL - CENTERLINE
- DB - DECK BEAM - (E)
- DS - DECK STRONGBACK - (E)
- G - GIRDER - (E)
- LS - LANDING STRONGBACK - (E)
- P - PIER - (E)
- U.O.N. - UNLESS OTHERWISE NOTED


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job no. 1406  
sheet



# CONSTRUCTION STAGING NOTES

- A. THIS WORK SHALL COMPLY WITH ALL 2013 CBC, CMC, CPC, CEC, CALIFORNIA ENERGY CODE, AND CALIFORNIA RESIDENTIAL CODE, AND ALL OTHER REGULATIONS AS AMENDED TO DATES APPROVED BY THE CITY OF SARATOGA.
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- C. THE CONTRACTOR SHALL MAINTAIN, KEEP IN SERVICE, AND PROTECT AGAINST DAMAGE, ALL EXISTING UTILITIES AND CITY SERVICES DURING CONSTRUCTION.
- D. IF THE CONTRACTOR FINDS THAT ANY ALLOCATED SPACE IS INSUFFICIENT TO PERFORM THE FUNCTION DESIGNATED TO IT, THE CONTRACTOR SHALL CONTACT THE ARCHITECT AT ONCE FOR DIRECTION BEFORE PROCEEDING WITH THE UTILIZATION OF THAT SPACE.
- E. THE CONTRACTOR SHALL PROMPTLY AND LEGALLY REMOVE ALL ACCUMULATED DEBRIS DAILY, SHALL PROTECT ALL EXPOSED MATERIALS FROM WEATHER ELEMENTS, AND SHALL SECURELY ENCLOSE THE CONSTRUCTION STAGING AREA AT THE END OF EACH DAY'S WORK.
- F. THE CONTRACTOR SHALL TAKE ALL NECESSARY PRECAUTIONARY MEASURES TO PROTECT THE PUBLIC, AND ADJACENT PROPERTIES FROM DAMAGE THROUGHOUT CONSTRUCTION.

02/11/14 11:05:39 AM, Steve Benzing - Architect

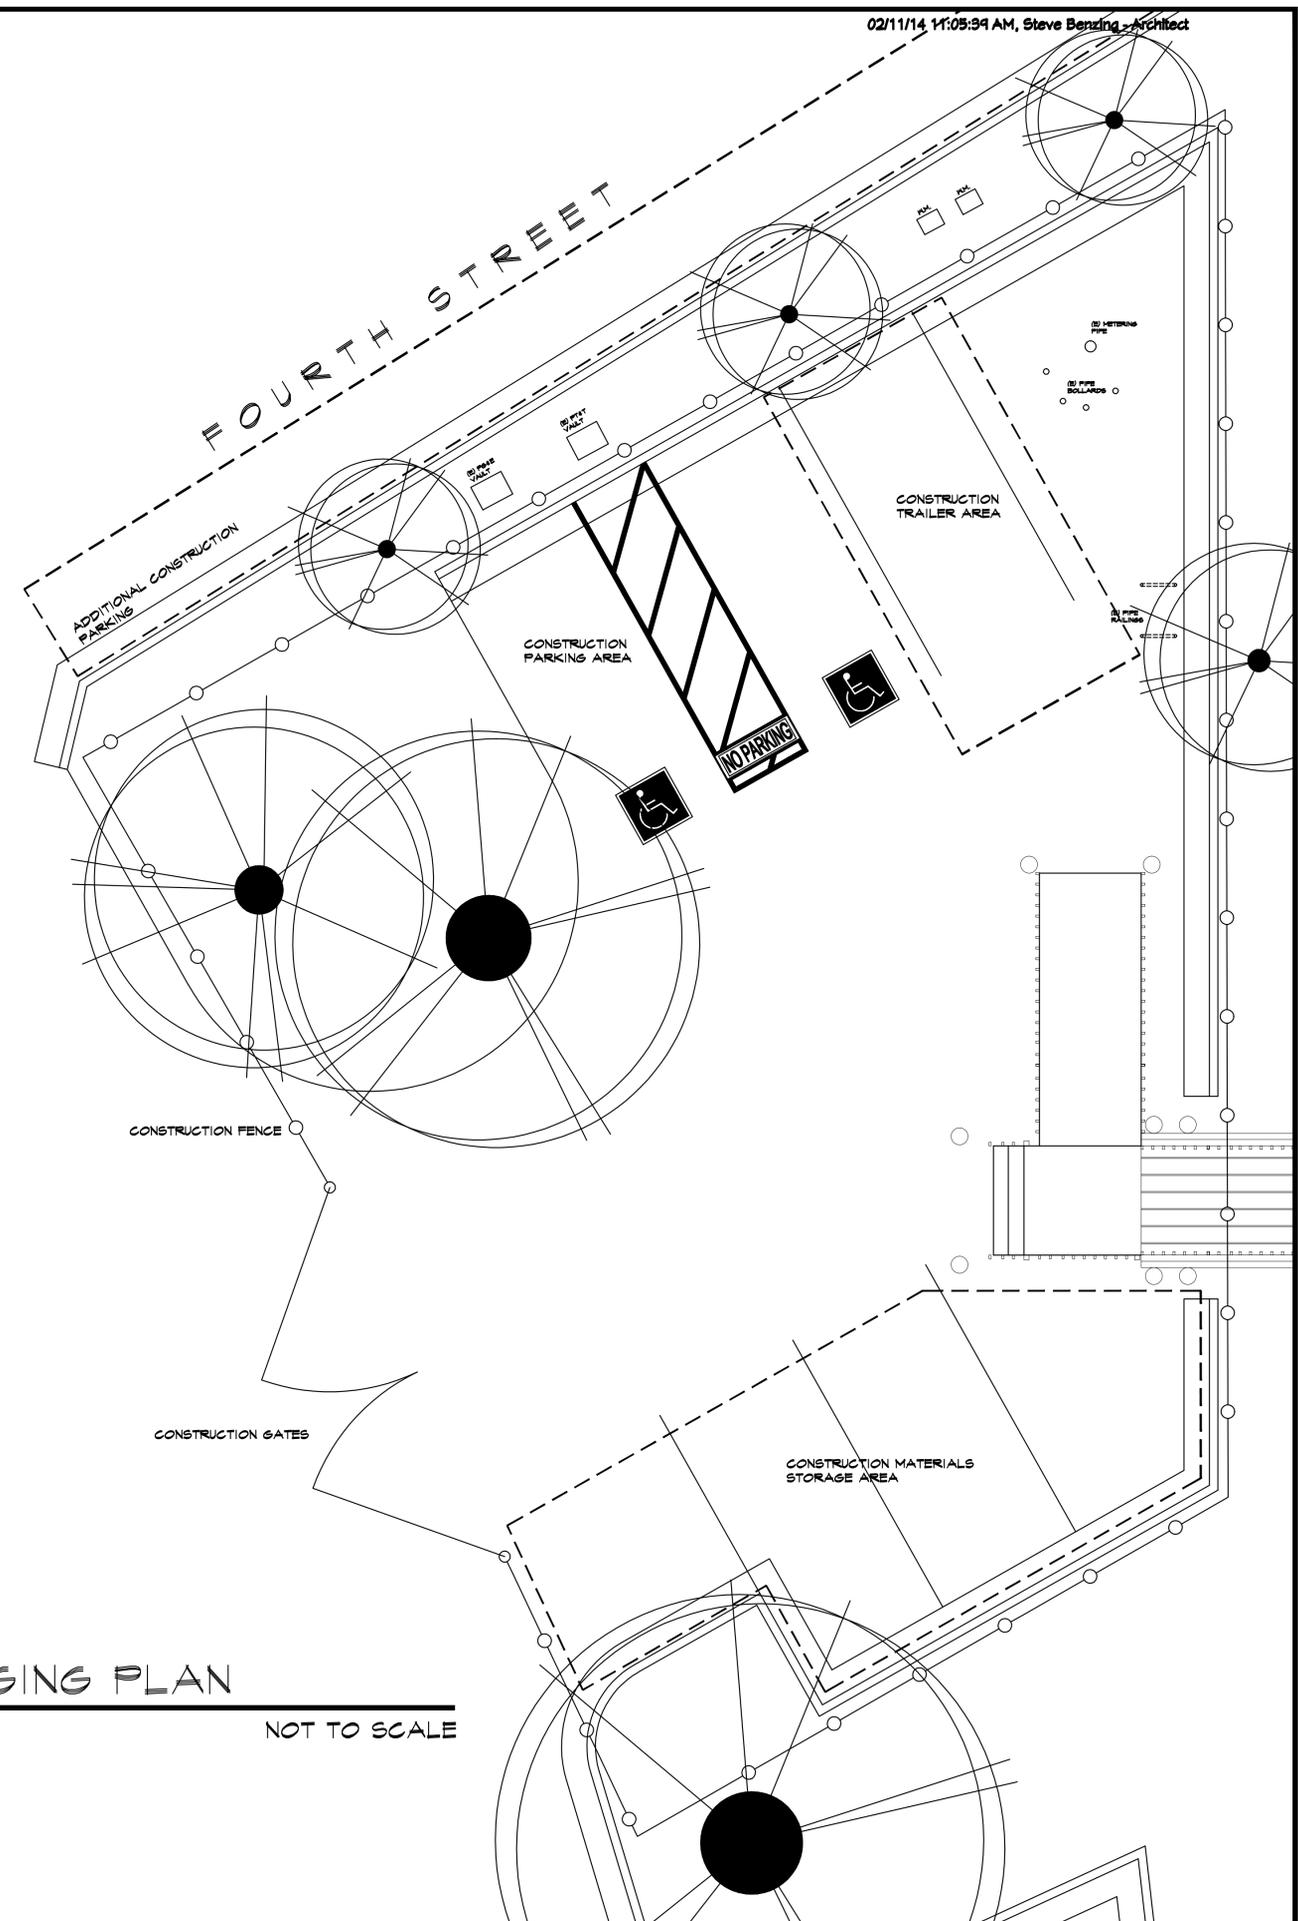

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## CONSTRUCTION STAGING PLAN

Renovations to  
Wilwood Park  
Pedestrian Bridge  
Saratoga, Ca

for:  
City of Saratoga  
13777 Fruitvale Ave.  
Saratoga, Ca

## CONSTRUCTION STAGING PLAN

NOT TO SCALE

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drawn by: SMB  
job no. 1406  
sheet


A2

of 10 shts


Steve Benzing  
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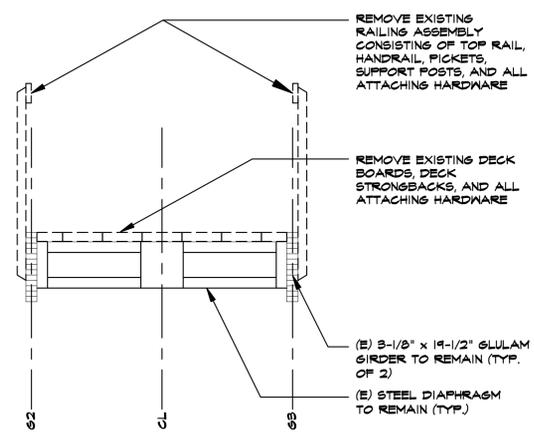
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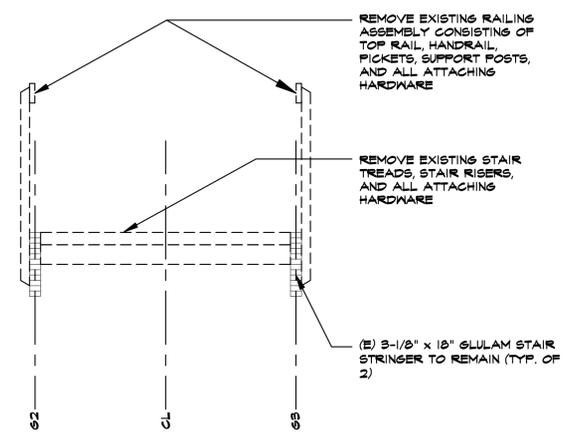
OVERALL EXISTING BRIDGE PLAN  
SCALE 1/8" = 1'-0"




DEMOLITION SECTION A-A  
SCALE 3/8" = 1'-0"

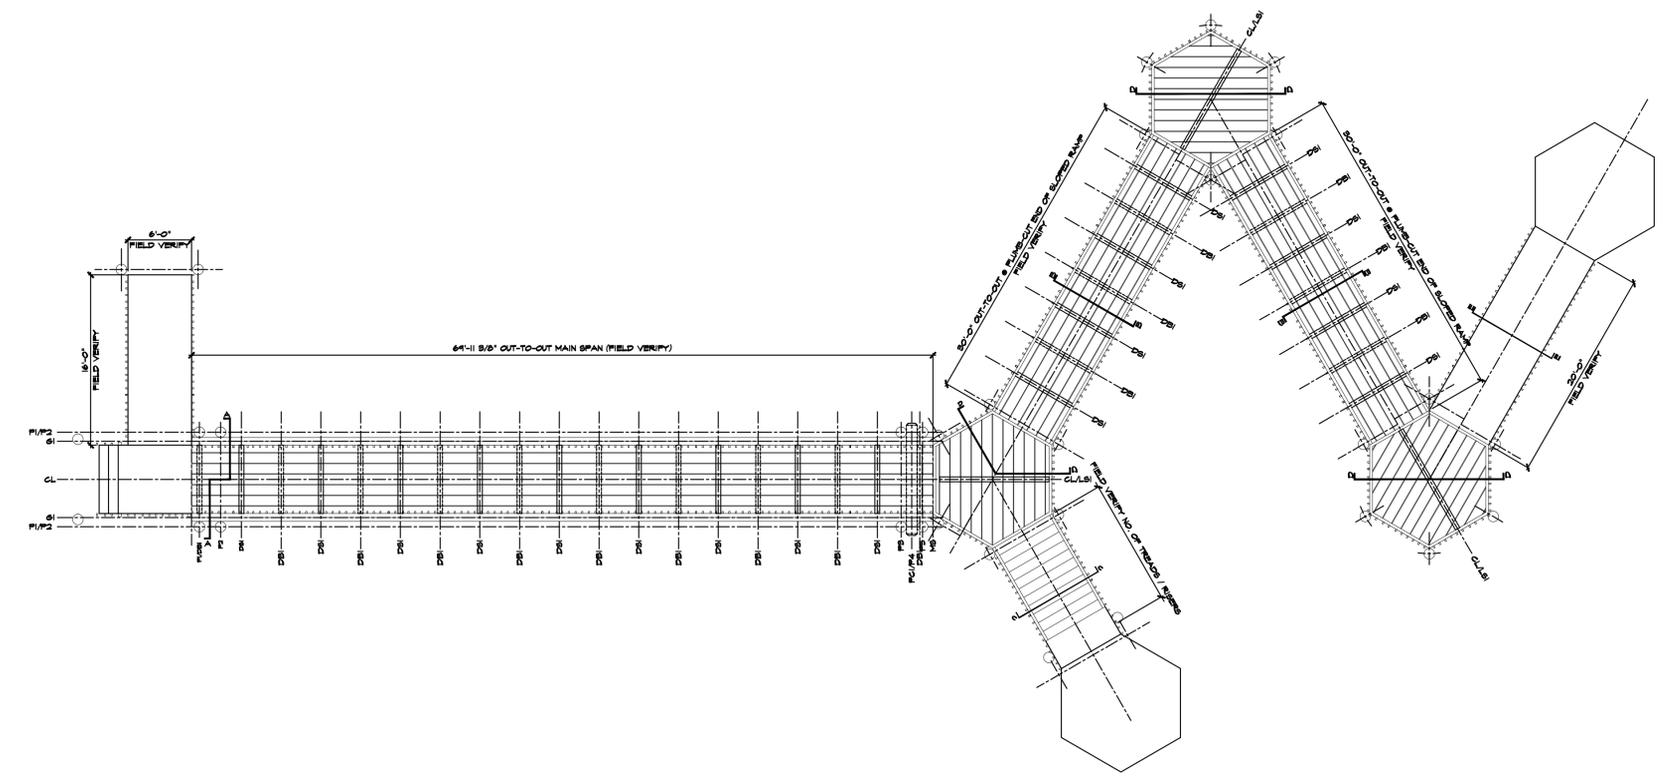


DEMOLITION SECTION B-B  
SCALE 3/8" = 1'-0"

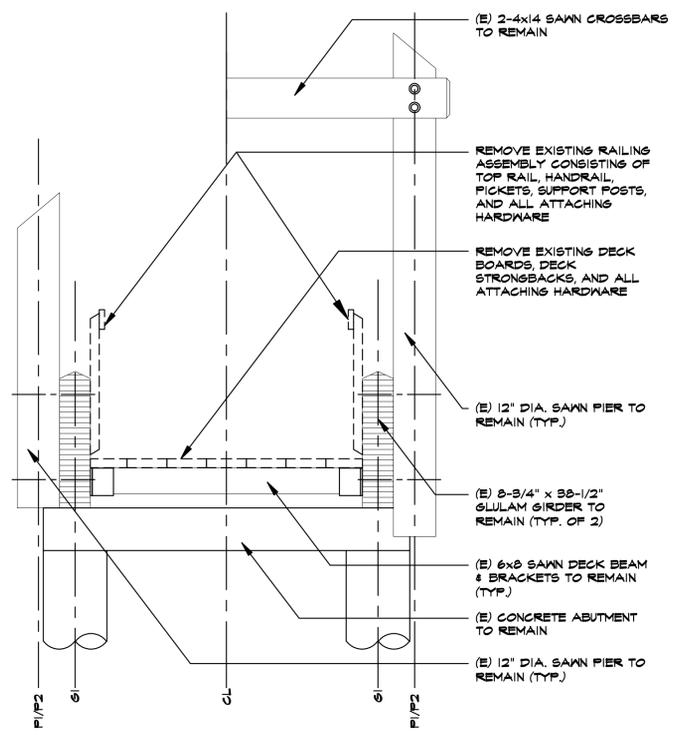

DEMOLITION SECTION C-C  
SCALE 3/8" = 1'-0"

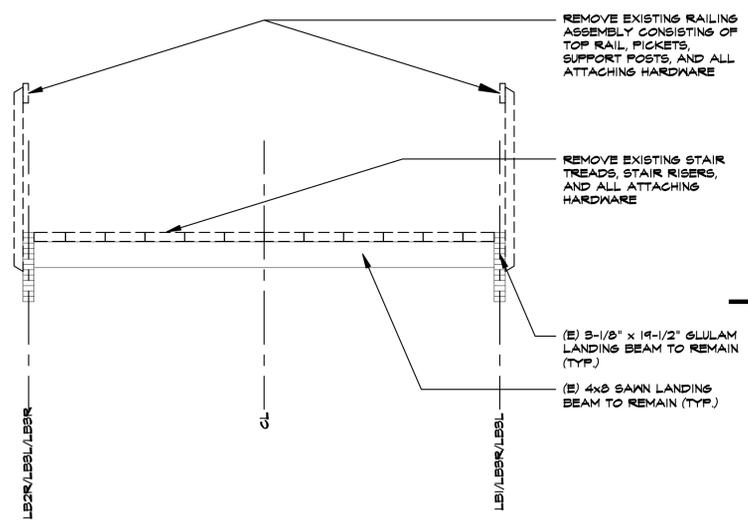

DEMOLITION SECTION D-D  
SCALE 3/8" = 1'-0"

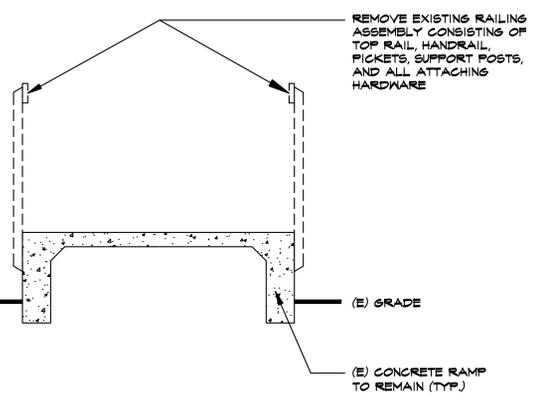

DEMOLITION SECTION E-E  
SCALE 3/8" = 1'-0"

EXISTING OVERALL  
BRIDGE PLAN &  
DEMOLITION  
SECTIONS

Renovations to  
Milwood Park  
Pedestrian Bridge  
Saratoga, Ca

for:  
City of Saratoga  
13777 Fruitvale Ave.  
Saratoga, Ca

date: 1/15/14  
scale: NOTED  
drawn by: SMB  
job no. 1406  
sheet

A3


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- F. NO CHANGES, MODIFICATIONS, OR DEVIATIONS SHALL BE MADE TO AND/OR FROM THE DRAWINGS AND/OR SPECIFICATIONS WITHOUT FIRST SECURING WRITTEN PERMISSION FROM THE ARCHITECT AND THE OWNER.
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## EXISTING/DEMO BRIDGE PLANS


Renovations to  
Wilwood Park  
Pedestrian Bridge  
Saratoga, Ca  
for:  
City of Saratoga  
13777 Fruitvale Ave.  
Saratoga, Ca

date: 1/15/14  
scale: NOTED  
drawn by: SMB  
job no. 1406  
sheet

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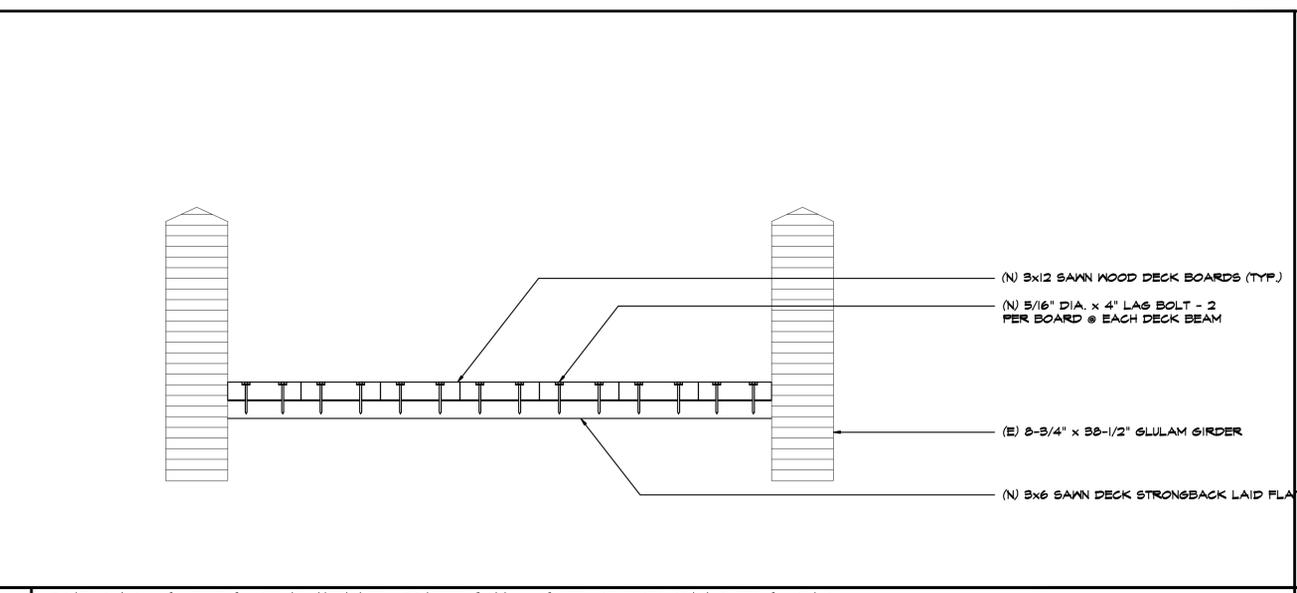
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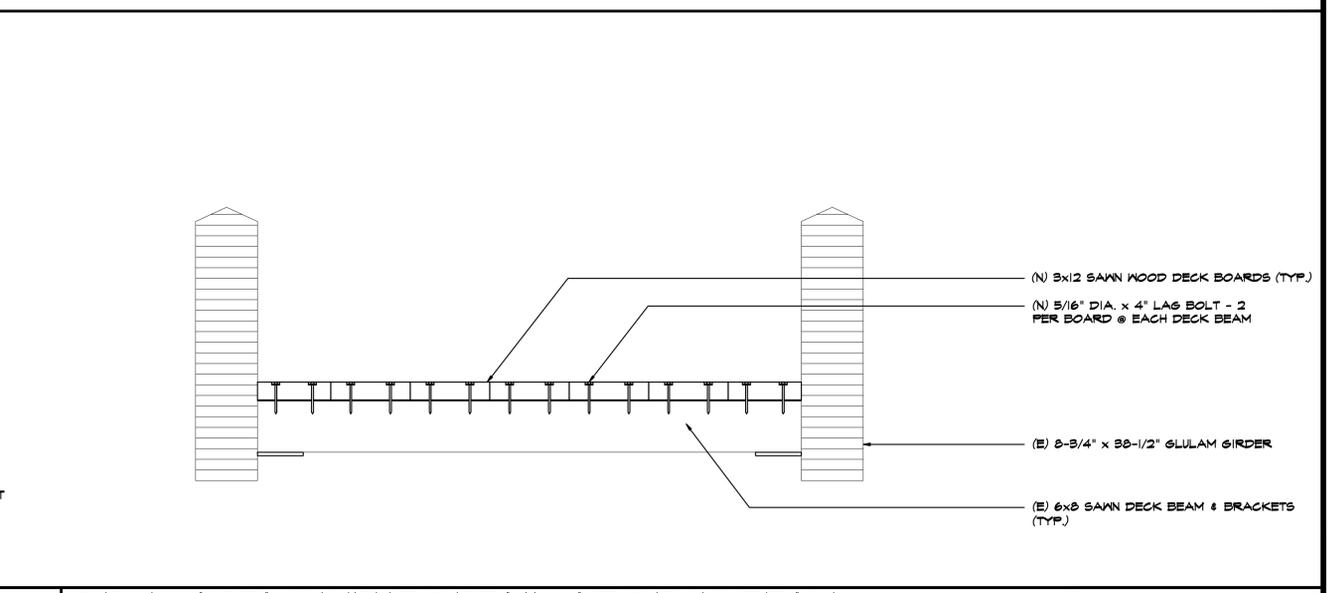


**PROPOSED OVERALL BRIDGE PLAN**

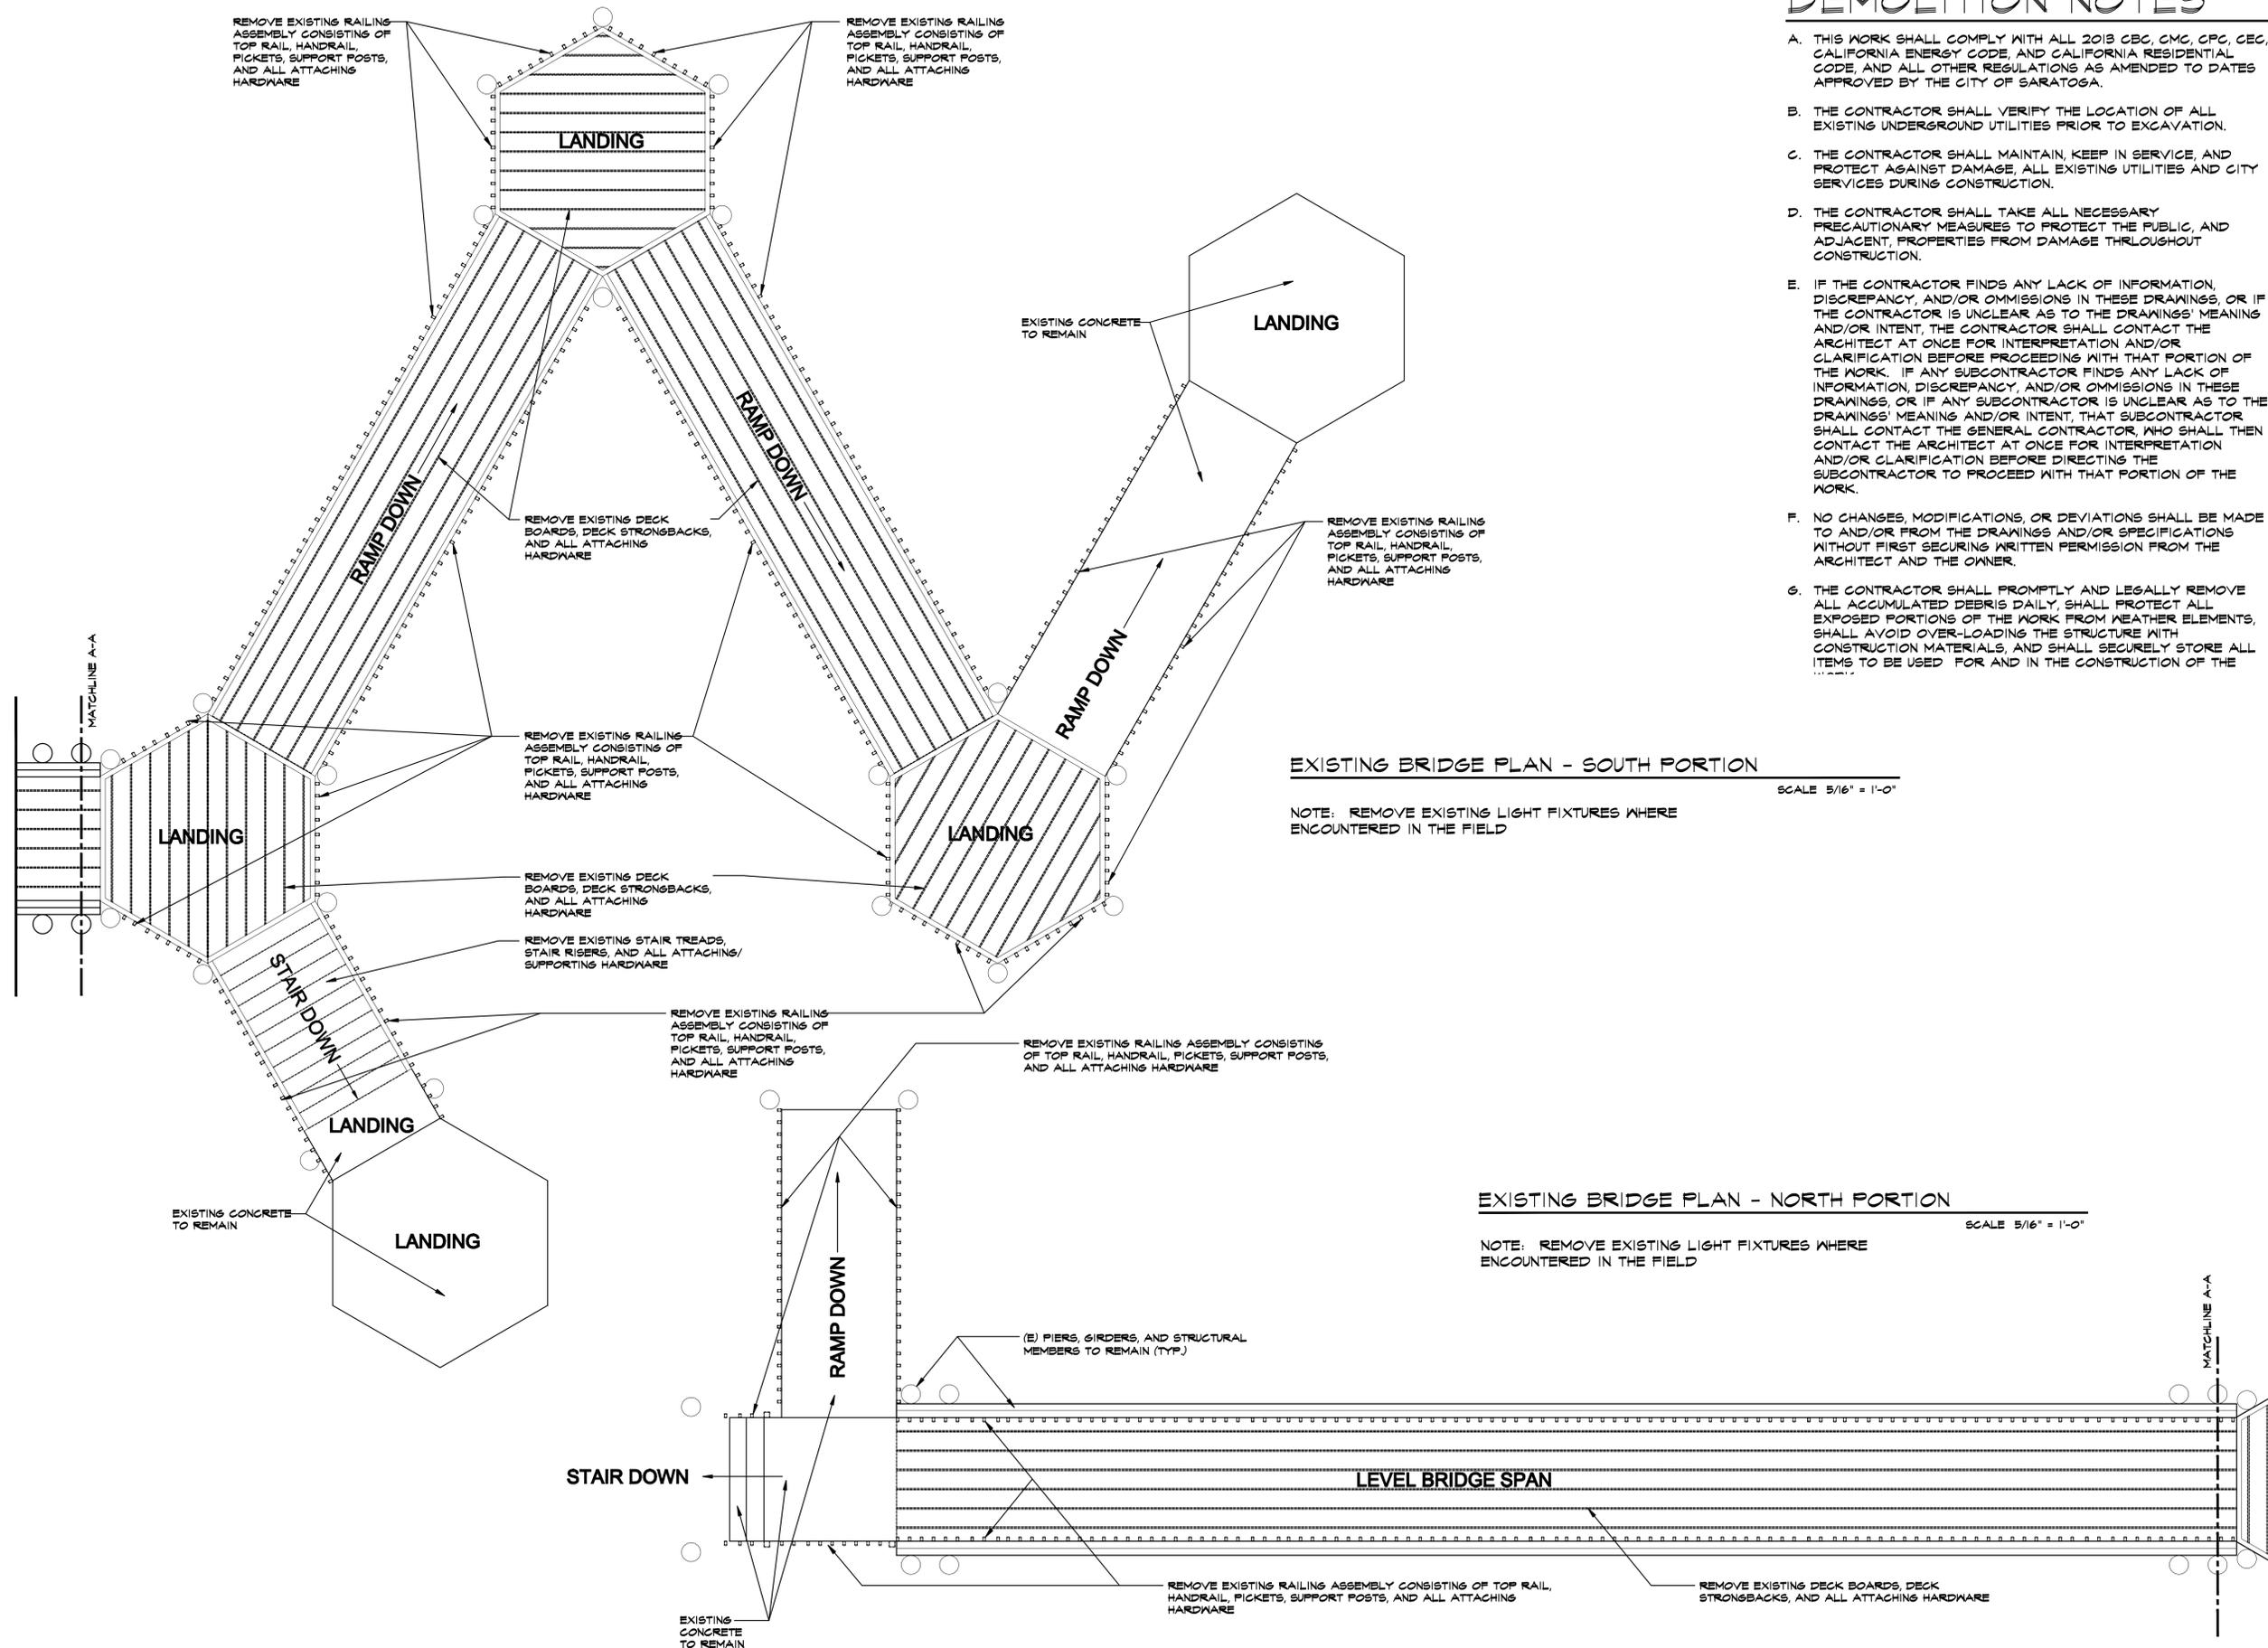EXISTING TO REMAIN NEW WORK   
 DB - (E) 6x8 SAWN DECK BEAM  
 DS - (E) 3x6 SAWN DECK STRONGBACK LAID FLAT  
 SEE SHEET A1 FOR ALL OTHER ABBREVIATIONS  
 SCALE 3/16" = 1'-0"

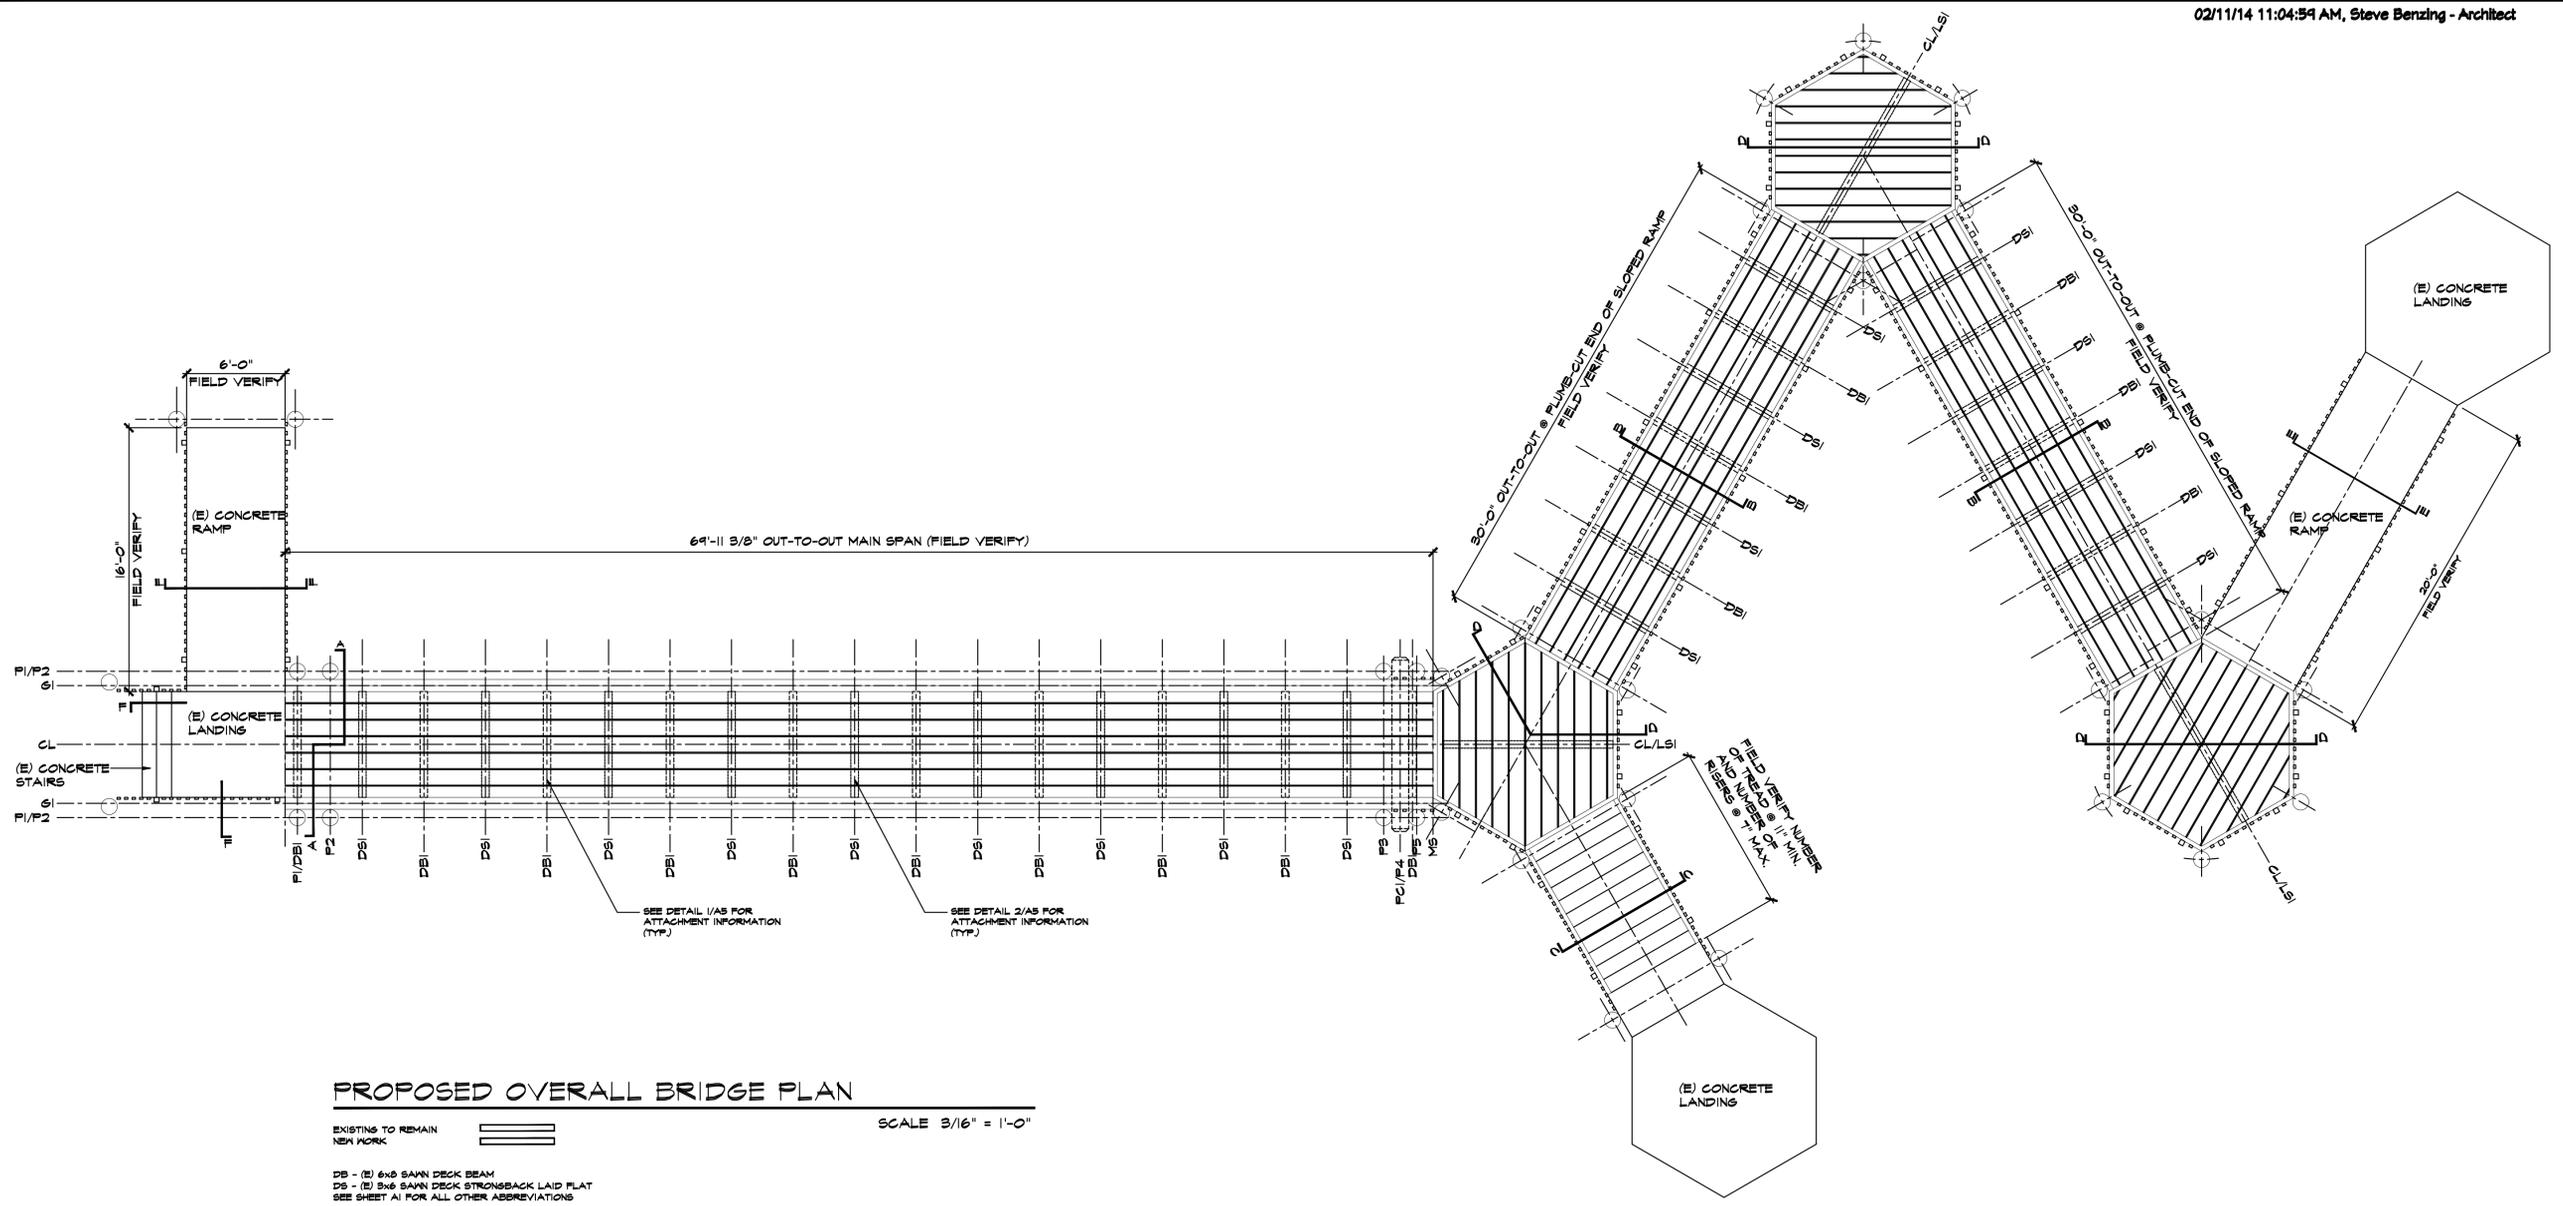

2 DECK ATTACHMENT DETAIL AT STRONGBACK



1 DECK ATTACHMENT DETAIL AT DECK BEAM

**OVERALL PROPOSED BRIDGE PLAN & DECK DETAILS**  
  
 Renovations to  
 Milwood Park  
 Pedestrian Bridge  
 Saratoga, Ca  
  
 for:  
 City of Saratoga  
 13777 Fruitvale Ave.  
 Saratoga, Ca

date: 1/15/14  
 scale: NOTED  
 drawn by: SMB  
 job no. 1406  
 sheet

A5


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- E. THE CONTRACTOR SHALL TAKE ALL NECESSARY PRECAUTIONARY MEASURES TO PROTECT THE PUBLIC, AND ADJACENT PROPERTIES FROM DAMAGE THROUGHOUT CONSTRUCTION.
- F. ALL LAG BOLTS SHALL BE "BRONZE STAR EXTERIOR STAR-DRIVE WOOD SCREWS" BY SCREEN PRODUCTS, INC. U.O.N.
- G. PRE-DRILL ALL NON-SELF-TAPPING LAG-SCREW LOCATIONS TO ENSURE THAT SPLITTING DOES NOT OCCUR IN ANY WOOD MEMBERS INVOLVED IN ATTACHMENT.
- H. ALL HEX BOLTS, DOCK WASHERS, AND NUTS SHALL BE STAINLESS STEEL, RATED FOR EXTERIOR USE.


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PROPOSED BRIDGE PLAN - SOUTH PORTION  
SCALE 5/16" = 1'-0"



PROPOSED BRIDGE PLAN - NORTH PORTION  
SCALE 5/16" = 1'-0"

**No Skidding® SUPER ACRYLIC HIGH PROFILE, SLIP RESISTANT GRAY # 97301**

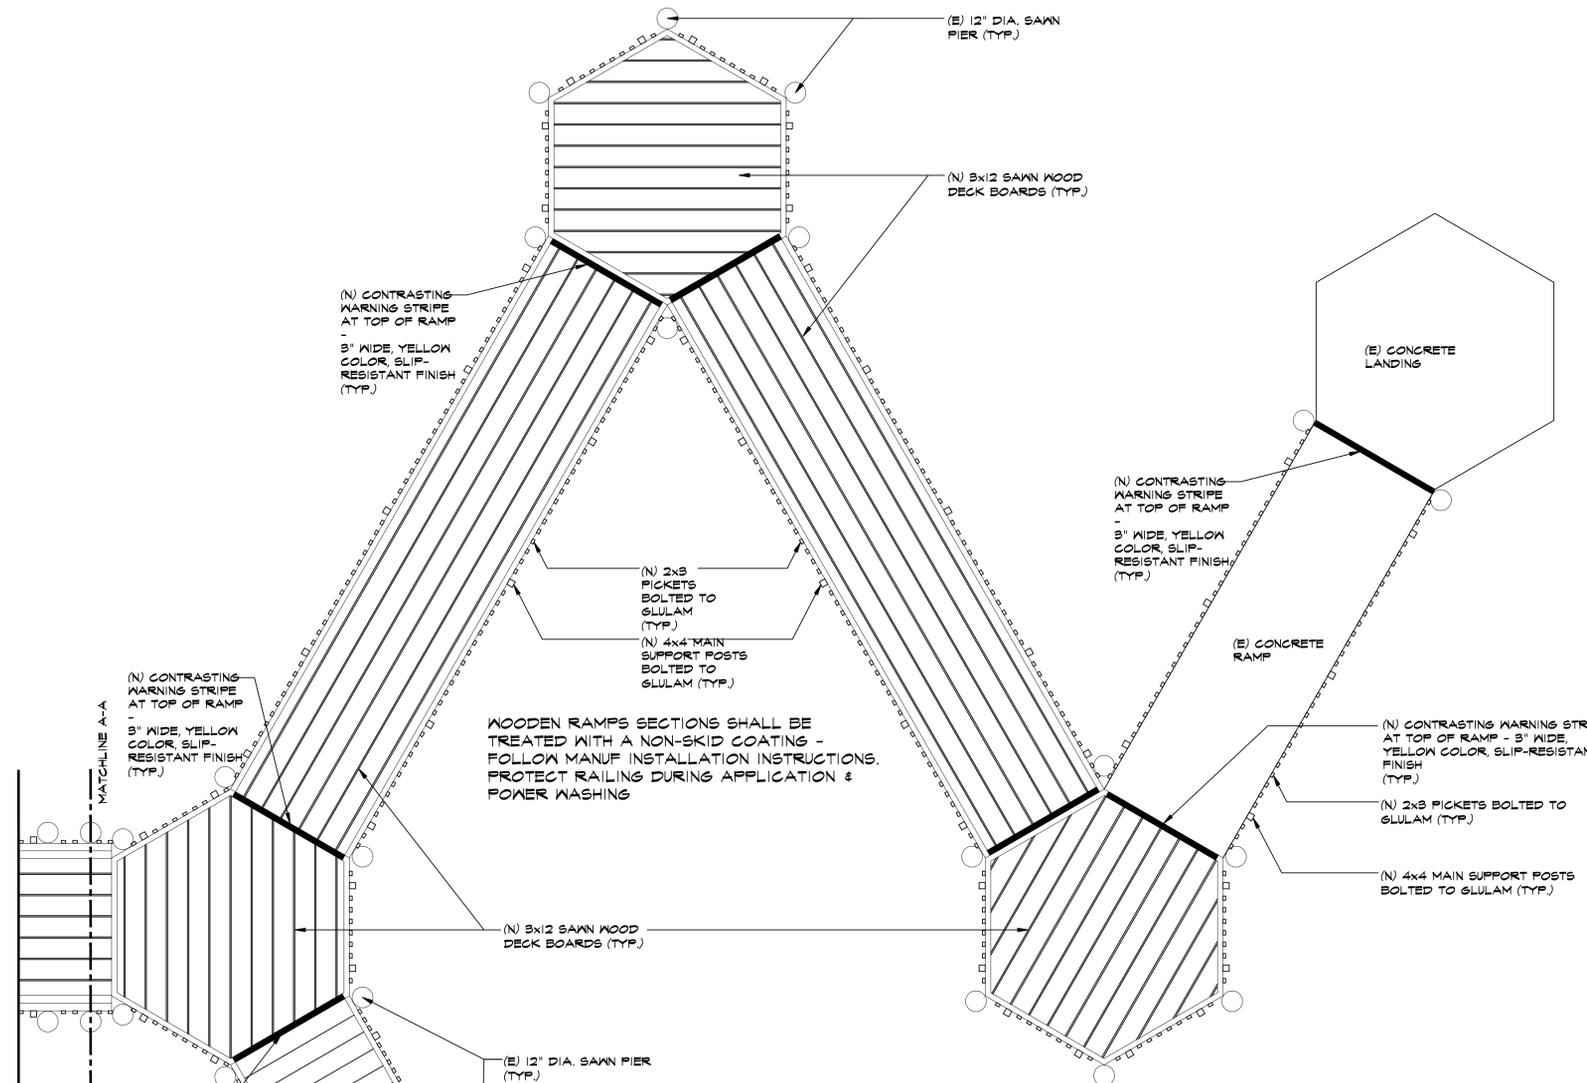Product Description:  

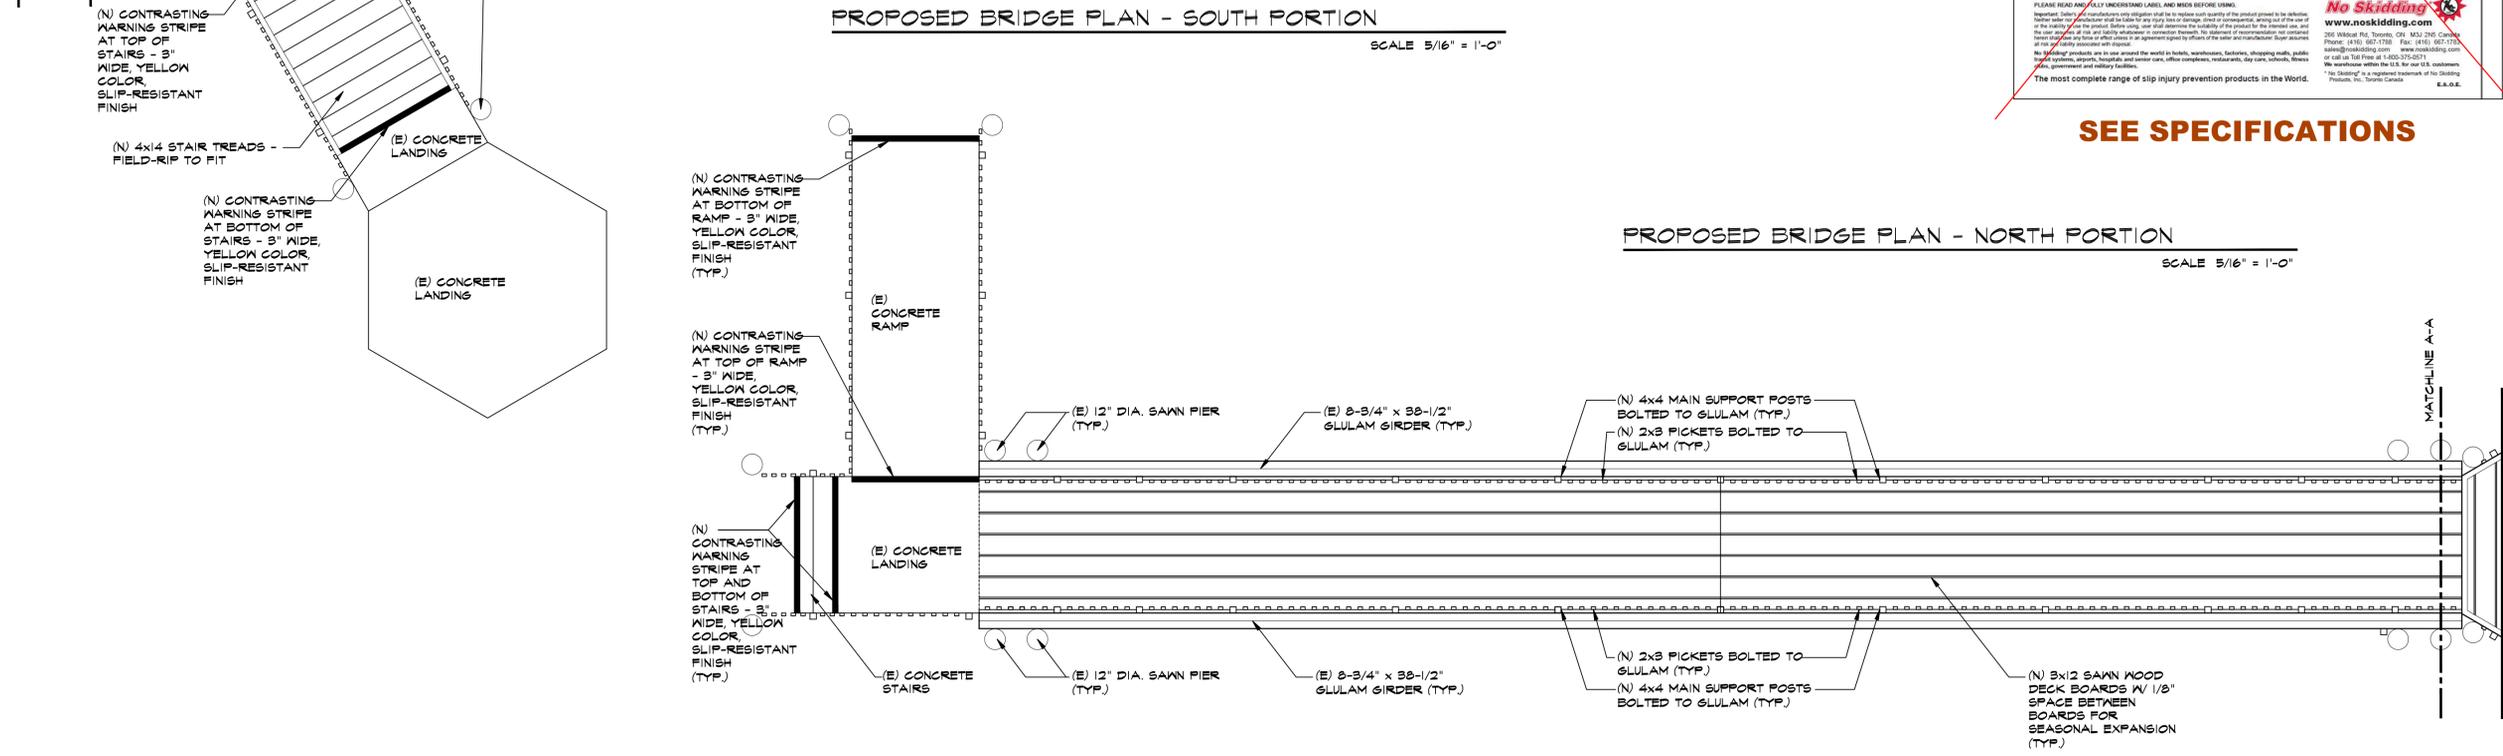- A single one part, non-solvent acrylic slip coating suitable for a variety of interior and exterior applications.
- No Skidding® Super Acrylic High Profile One Part also resists weathering, abrasion and mild chemicals.
- Significantly reduces the chances of slipping, although this product cannot totally prevent the possibility of slipping.
- Low odor and low VOC.
- Stays in water clean.

Recommended Primers:  

- Metal and Rust-Resistant Primers
- Galvanizing/Aluminized Metal Primer
- Masonry/Block/Concrete & Weathered Asphalt/No primer required

Recommended Application:  

- Brush or Low Profile Roller; Recommended
- Spray; Not recommended
- Airless; Not recommended

Application Temperature:  

- Minimum: 50°F Maximum: 90°F

Storage Temperature:  

- Minimum: 35°F Maximum: 120°F

Drying Time (Good Conditions):  

- Tack Free: 2 Hours To Recoat: 18-24 Hours
- Hard: 7-14 Days

Physical Data:  

- Gloss Rating: Flat
- Percent Solids: Weight 63.9±2.0%, Volume 45.7±2.0%
- Net Wt. Per Gal: 12.6±0.25 Imperial
- VOC Category: 2.1 Imperial (250 grams/litre)
- Flash Point: 158°F Closed Cup
- Viscosity: 125-130 K.U.

Surface Preparation & Application Instructions:  

- All surfaces must be clean and free of dust, dirt, grease, oil, soap residue, loose paint, glaze and any other foreign matter. Test results, the status of any previous paint failure should be corrected before repainting.
- New masonry surfaces should cure 30 days before being coated. Concrete that is new, smooth troweled, or suspended of being treated with chemical de-icers needs to be etched with a 10% solution of muriatic acid and allowed to thoroughly dry before painting. Glossy surfaces should be dulled with the sandpaper to ensure proper adhesion. Unpainted metal surfaces must be primed with metal primer before coating.
- Floor is dry to walk on after 24 hours under good drying conditions.
- Pressure Washed wood floor wash thoroughly to remove oils in the wood before application.

Recommended Film Thickness Per Coat:  

- Wet: 12-14 mils Dry: 5.0-6.0 mils
- "Clean up with soap and water"

Package & Identification:  

- Freight Class: Non-Hazardous Paint
- MSDS: Available upon request

www.noskidding.com  
 200 Walnut St. Saratoga, CA 95070  
 Phone: (415) 667-1738 Fax: (415) 667-1738  
 email: sales@noskidding.com www.noskidding.com  
 or call us Toll Free at 1-800-235-0271  
 We warehouse within the U.S. for our U.S. customers.

The most complete range of slip injury prevention products in the World.  
 \*No Skidding® is a registered trademark of No Skidding Products, Inc. Saratoga, California E.A.O.C.

SEE SPECIFICATIONS

## PROPOSED BRIDGE PLANS

Renovations to  
Milwood Park  
Pedestrian Bridge  
Saratoga, Ca

For:  
City of Saratoga  
13777 Fruitvale Ave.  
Saratoga, Ca

REVISIONS: 3/3/14 - RAILING LOCATION


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A6


Steve Benzing  
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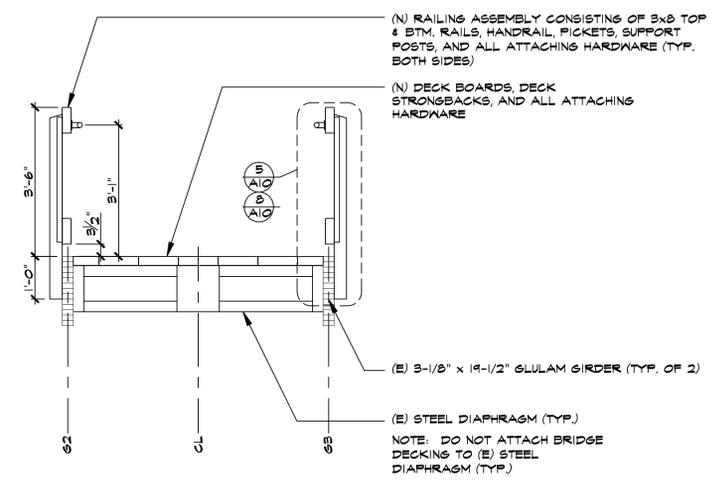
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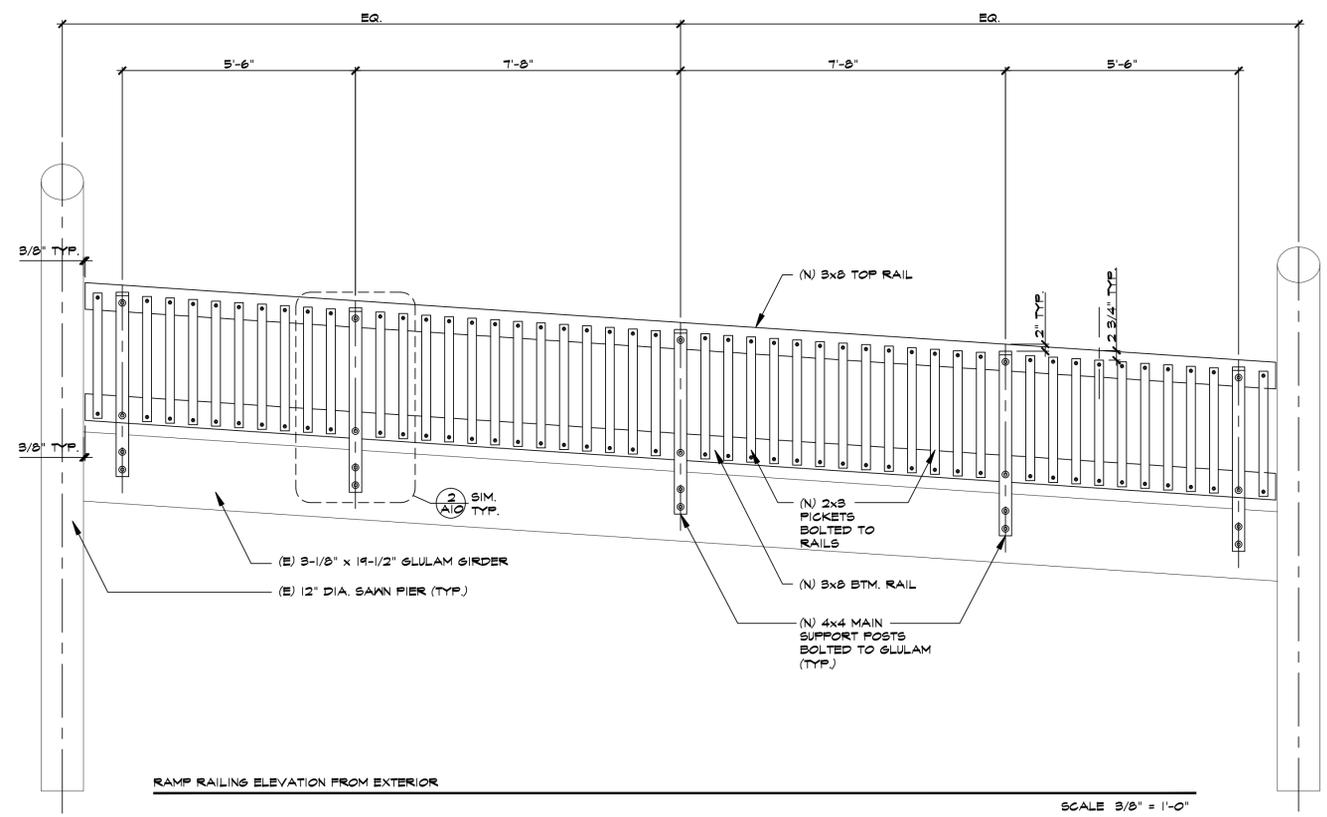
BRIDGE SECTION A-A  
SCALE 3/8" = 1'-0"



BRIDGE RAILING ELEVATION FROM BRIDGE INTERIOR  
SCALE 3/8" = 1'-0"

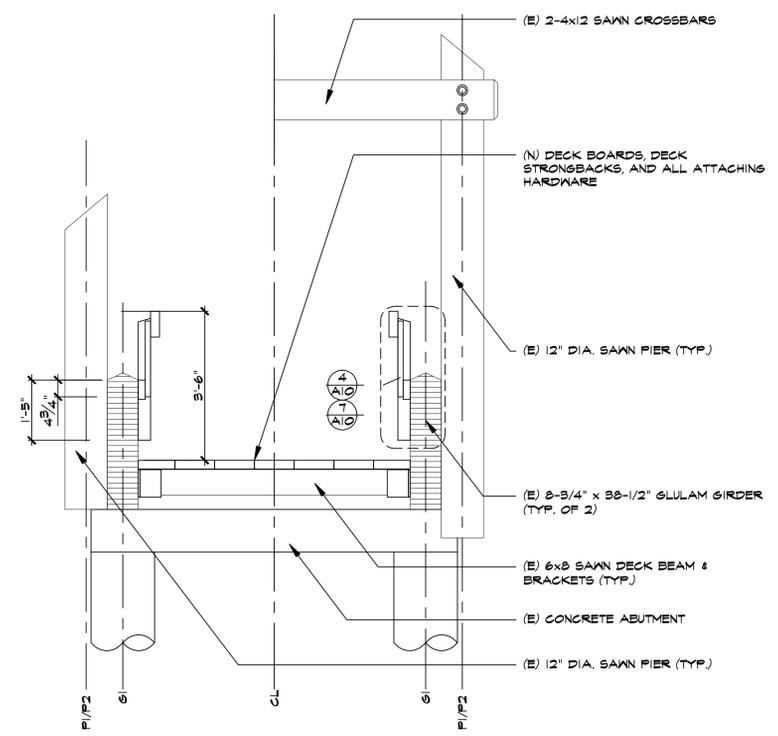

RAMP SECTION B-B  
SCALE 3/8" = 1'-0"

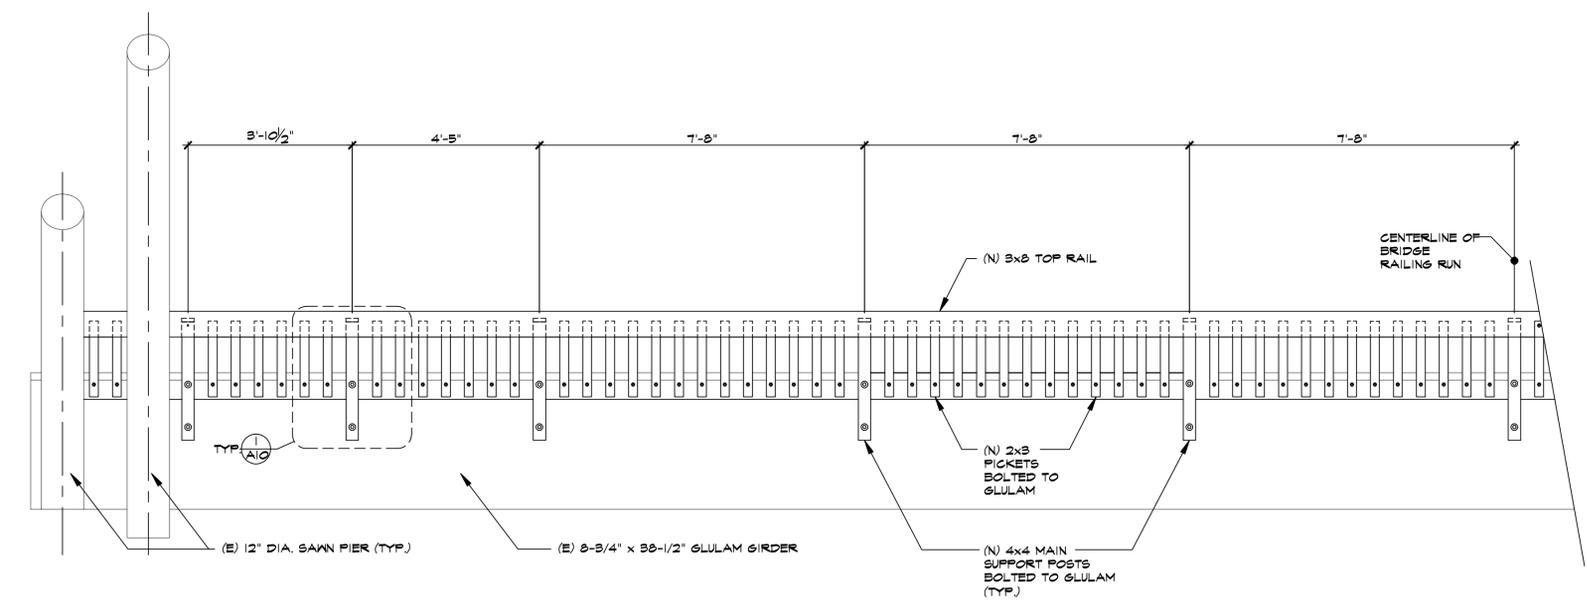

RAMP RAILING ELEVATION FROM EXTERIOR  
SCALE 3/8" = 1'-0"

SECTIONS & RAILING ELEVATIONS

Renovations to  
Willwood Park  
Pedestrian Bridge  
Saratoga, Ca

for:  
City of Saratoga  
13777 Fruitvale Ave.  
Saratoga, Ca

REVISIONS: 3/3/14 - RAILING LOCATION


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A7


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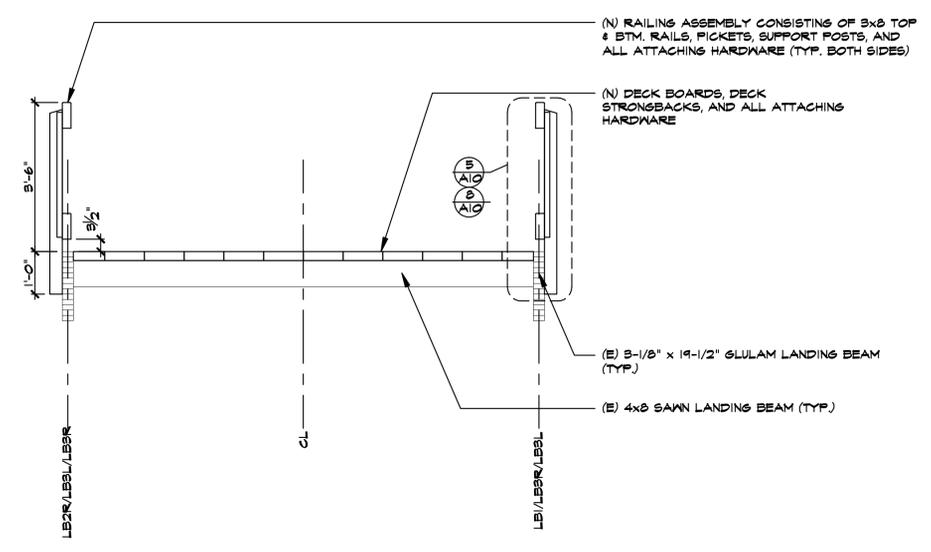
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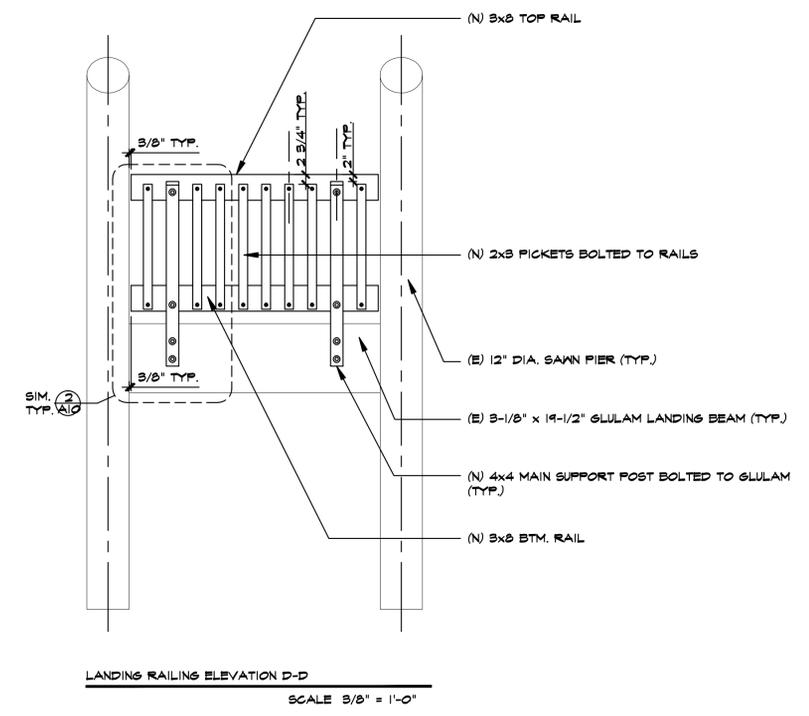
STAIR SECTION C-C  
SCALE 3/8" = 1'-0"



STAIR RAILING ELEVATION C-C  
SCALE 3/8" = 1'-0"

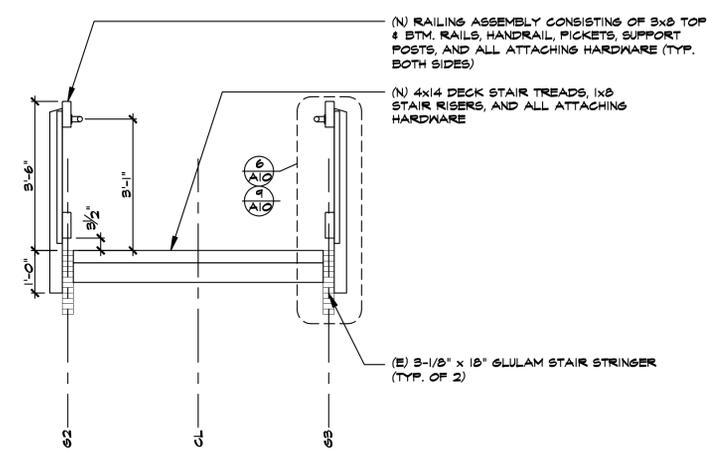

LANDING SECTION D-D  
SCALE 3/8" = 1'-0"

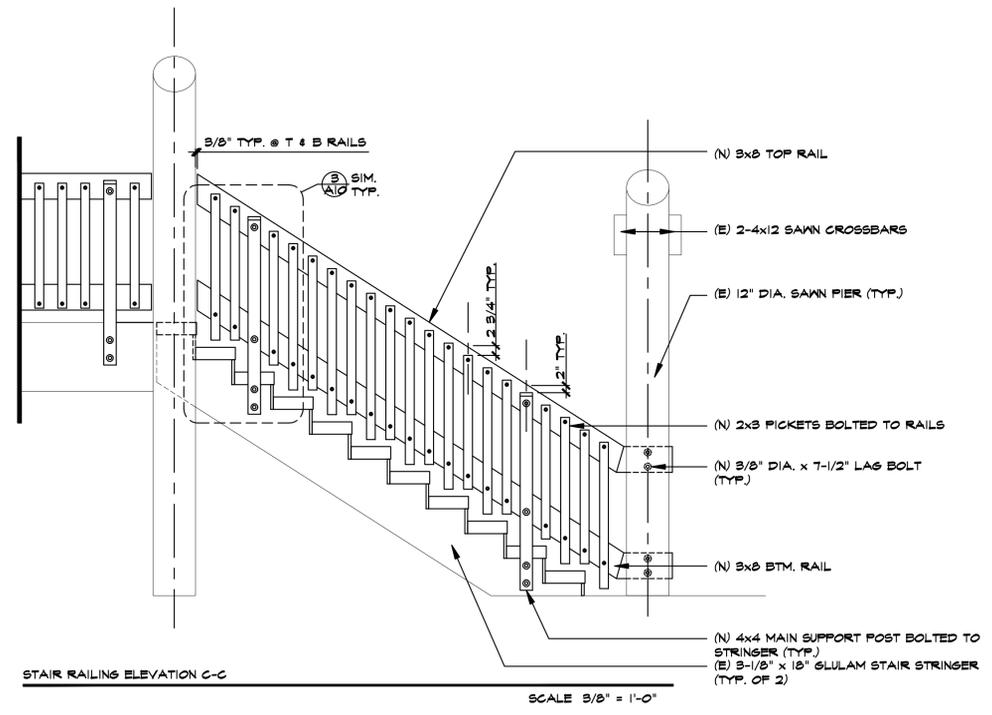

LANDING RAILING ELEVATION D-D  
SCALE 3/8" = 1'-0"

SECTIONS & RAILING ELEVATIONS

Renovations to  
Willwood Park  
Pedestrian Bridge  
Saratoga, Ca

for:  
City of Saratoga  
13777 Fruitvale Ave.  
Saratoga, Ca


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job no. 1406  
sheet

A8


Steve Benzing  
Architect  
C-17485

12403 Fredericksburg  
Saratoga California  
tel 408 805 1328  
email Steve@Benzarch.com  
Website: Benzarch.com


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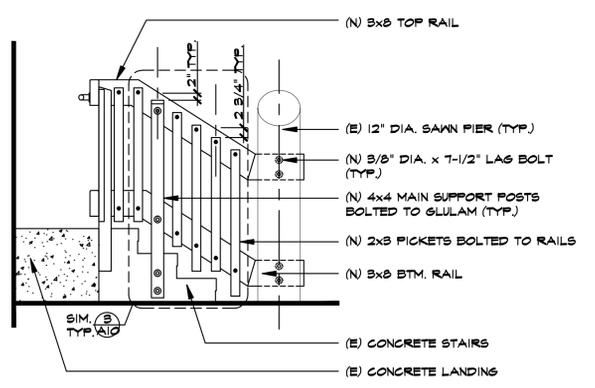
CONCRETE RAMP / RAISED LANDING SECTION E-E  
SCALE 3/8" = 1'-0"

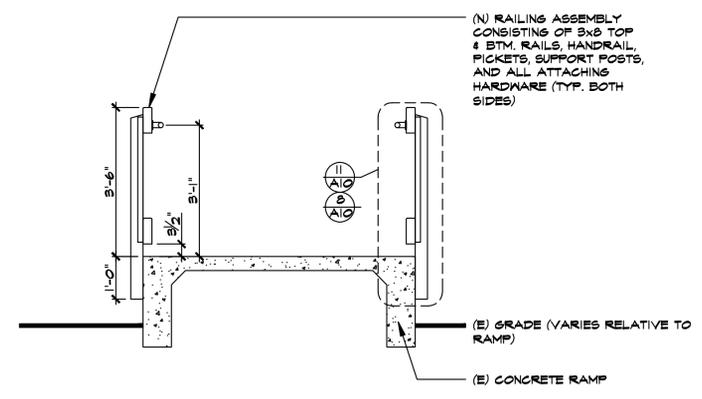


CONCRETE RAMP RAILING ELEVATION E-E  
SCALE 3/8" = 1'-0"

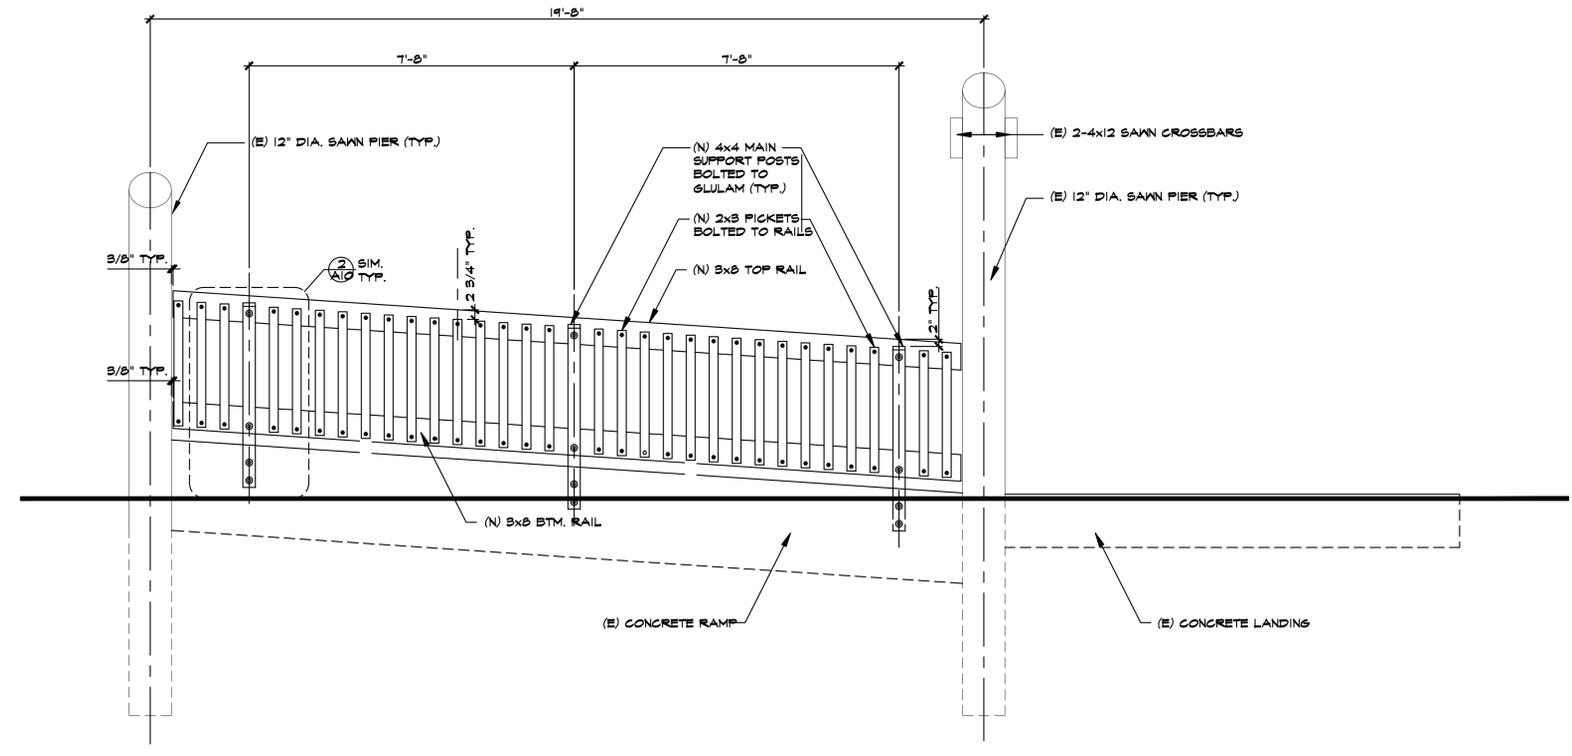

CONCRETE STAIR & RAMP SECTION F-F  
SCALE 3/8" = 1'-0"

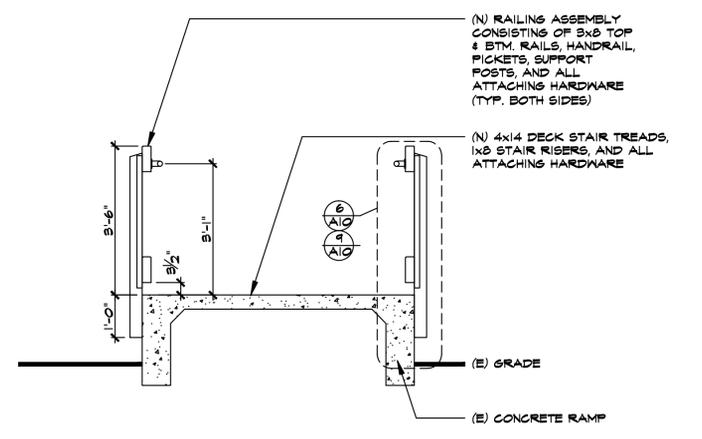

CONCRETE STAIR RAILING ELEVATION F-F  
SCALE 3/8" = 1'-0"

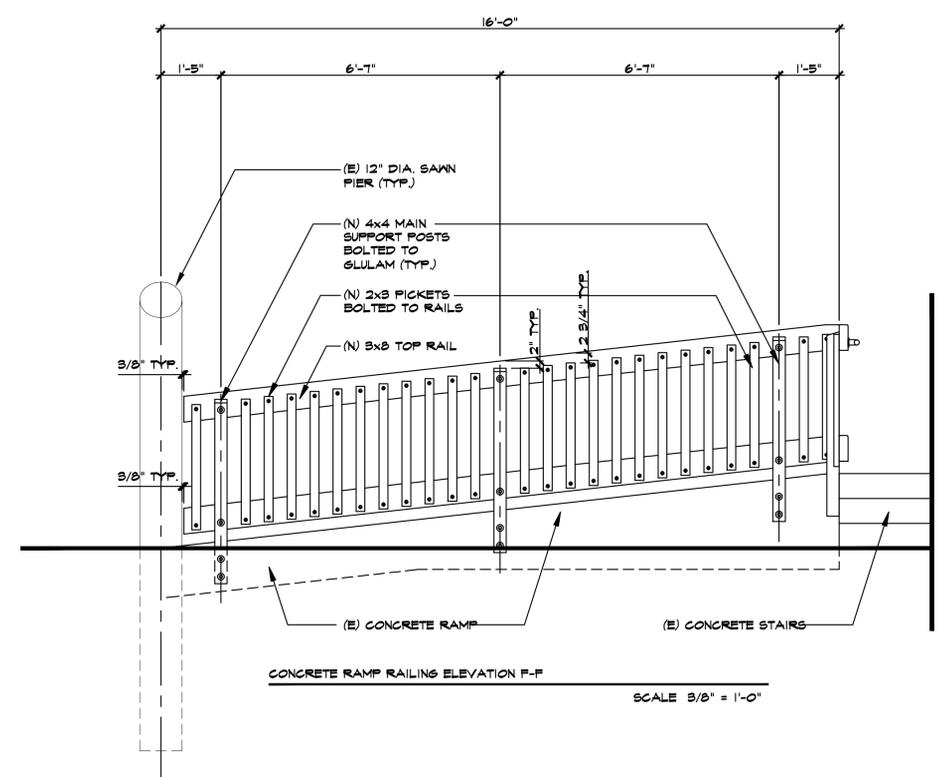





CONCRETE RAMP RAILING ELEVATION F-F  
SCALE 3/8" = 1'-0"

SECTIONS & RAILING ELEVATIONS

Renovations to  
Willwood Park  
Pedestrian Bridge  
Saratoga, Ca  
for:  
City of Saratoga  
13777 Fruitvale Ave.  
Saratoga, Ca

date: 1/15/14  
scale: NOTED  
drawn by: SMB  
job no. 1406  
sheet



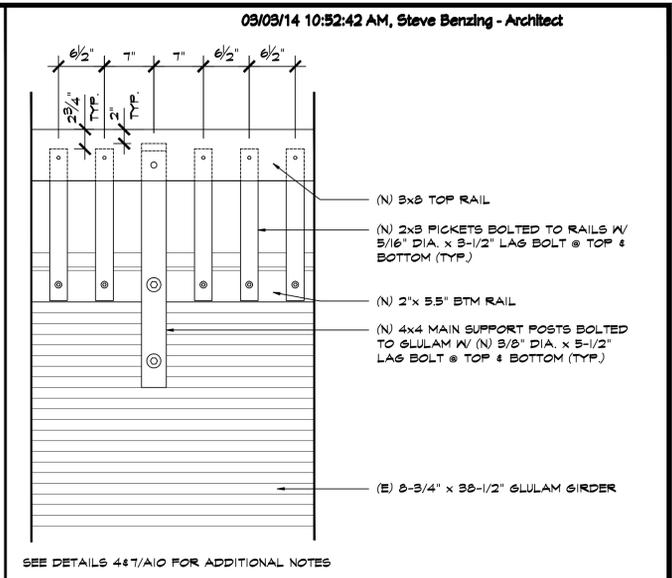
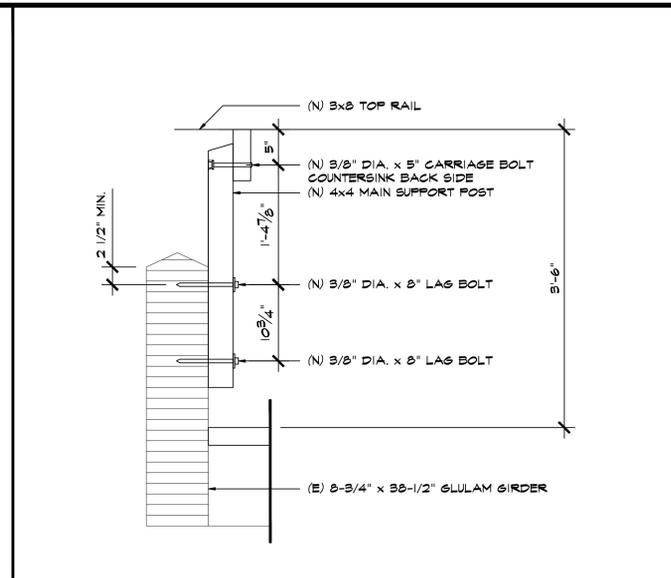
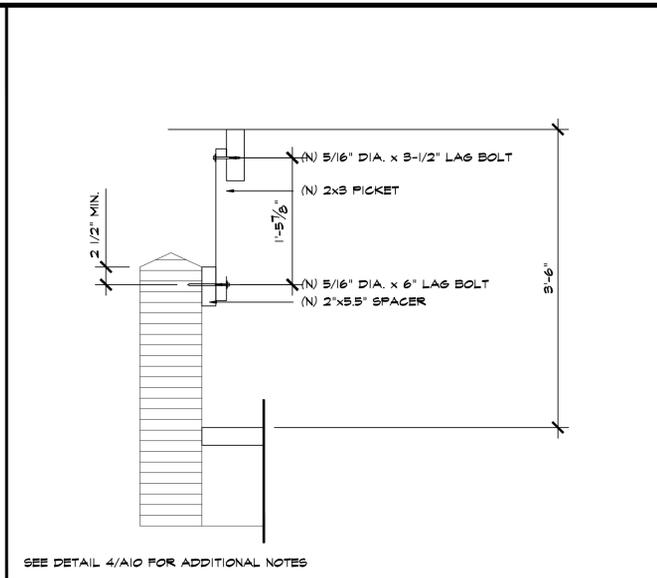
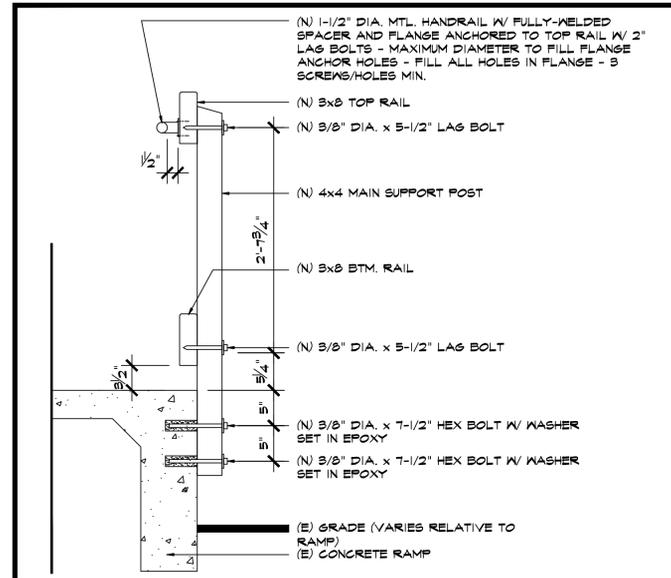


10 TYPICAL CONCRETE RAMP RAILING MAIN SUPPORT POST DETAIL N.T.S.

7 TYPICAL BRIDGE RAILING PICKET DETAIL N.T.S.

4 TYPICAL BRIDGE RAILING MAIN SUPPORT POST DETAIL N.T.S.

1 TYPICAL BRIDGE RAILING DETAIL N.T.S.

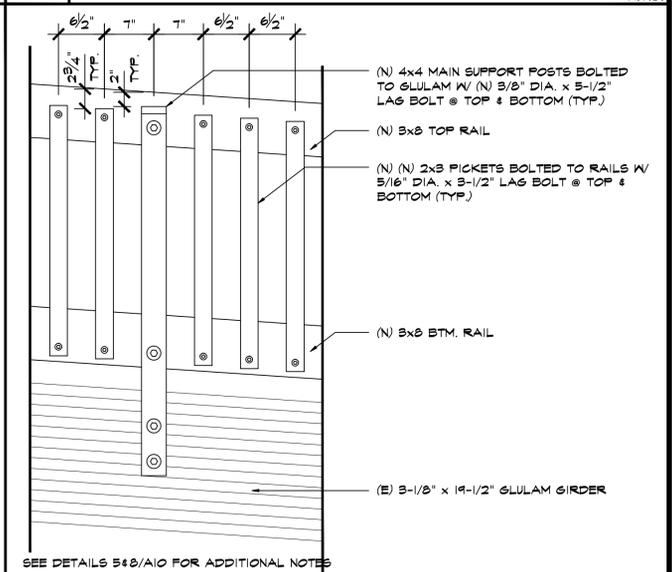
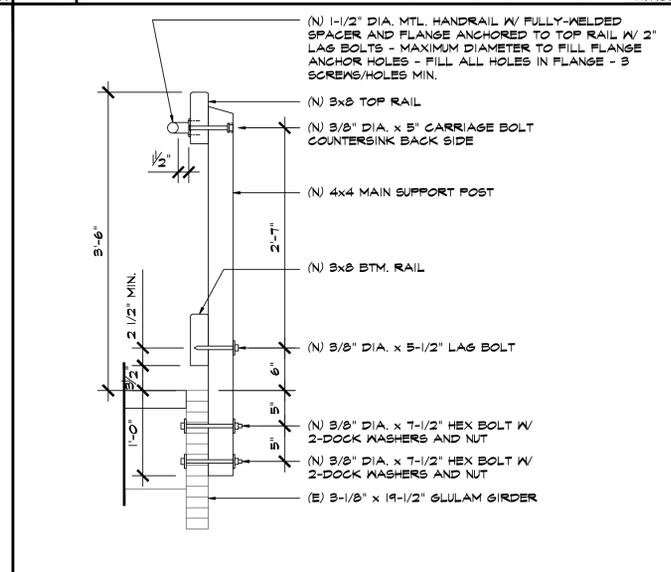
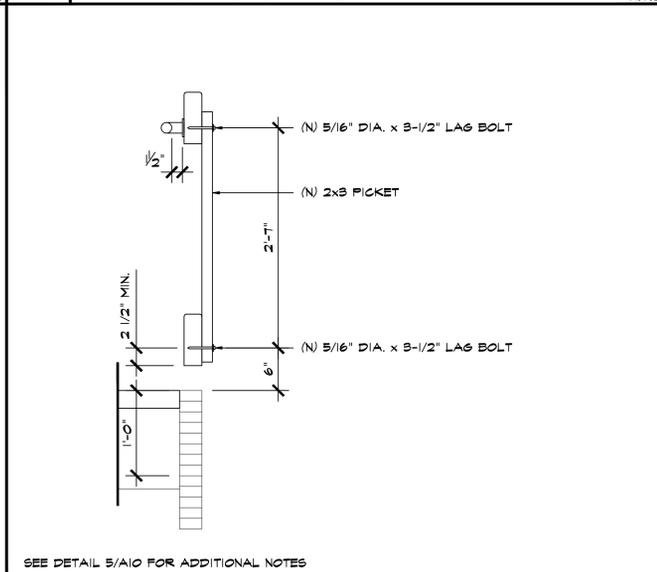
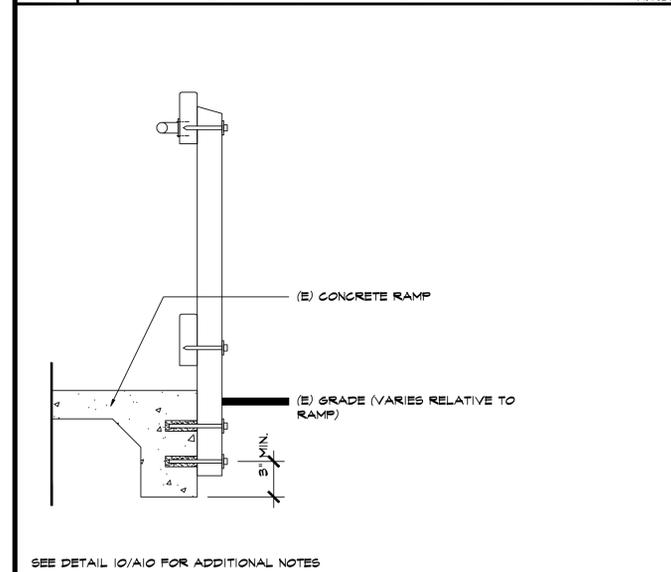


11 TYPICAL CONCRETE RAMP RAILING MAIN SUPPORT POST DETAIL N.T.S.

8 TYPICAL RAMP RAILING PICKET DETAIL N.T.S.

5 TYPICAL RAMP RAILING MAIN SUPPORT POST DETAIL N.T.S.

2 TYPICAL RAMP RAILING DETAIL N.T.S.

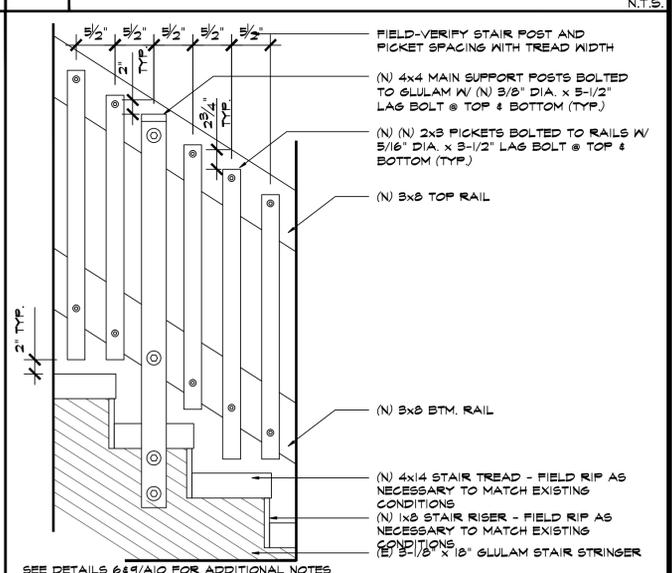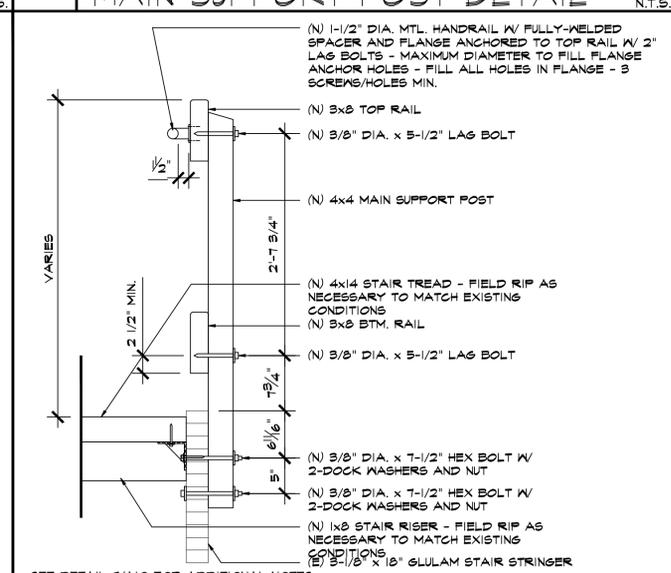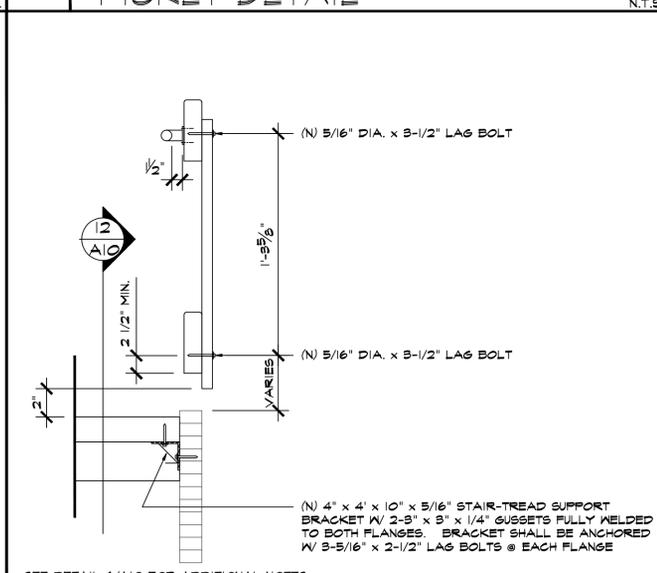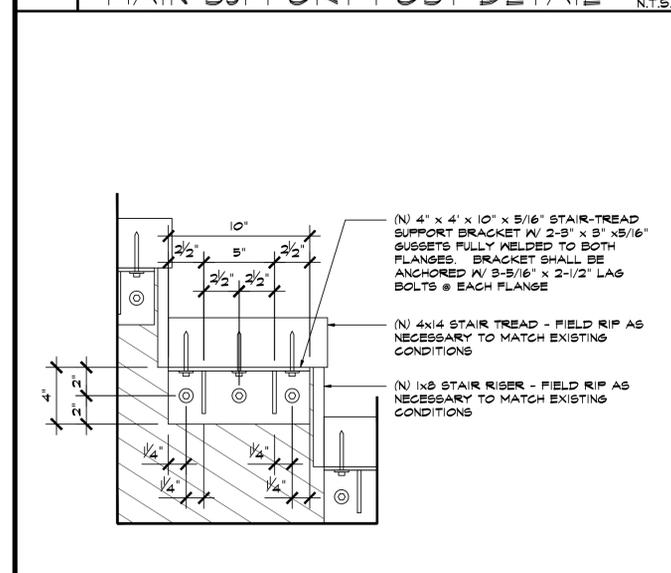

12 TYPICAL STAIR TREAD / RISER DETAIL N.T.S.

9 TYPICAL STAIR RAILING PICKET DETAIL N.T.S.

6 TYPICAL STAIR RAILING MAIN SUPPORT POST DETAIL N.T.S.

3 TYPICAL STAIR RAILING DETAIL N.T.S.

03/03/14 10:52:42 AM, Steve Benzing - Architect

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DETAILS

Renovations to  
Milwood Park  
Pedestrian Bridge  
Saratoga, Ca

for:  
City of Saratoga  
13777 Fruitvale Ave.  
Saratoga, Ca

REVISIONS: 3/3/14 - RAILING LOCATION

date: 1/15/14  
scale: NOTED  
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job no. 1406  
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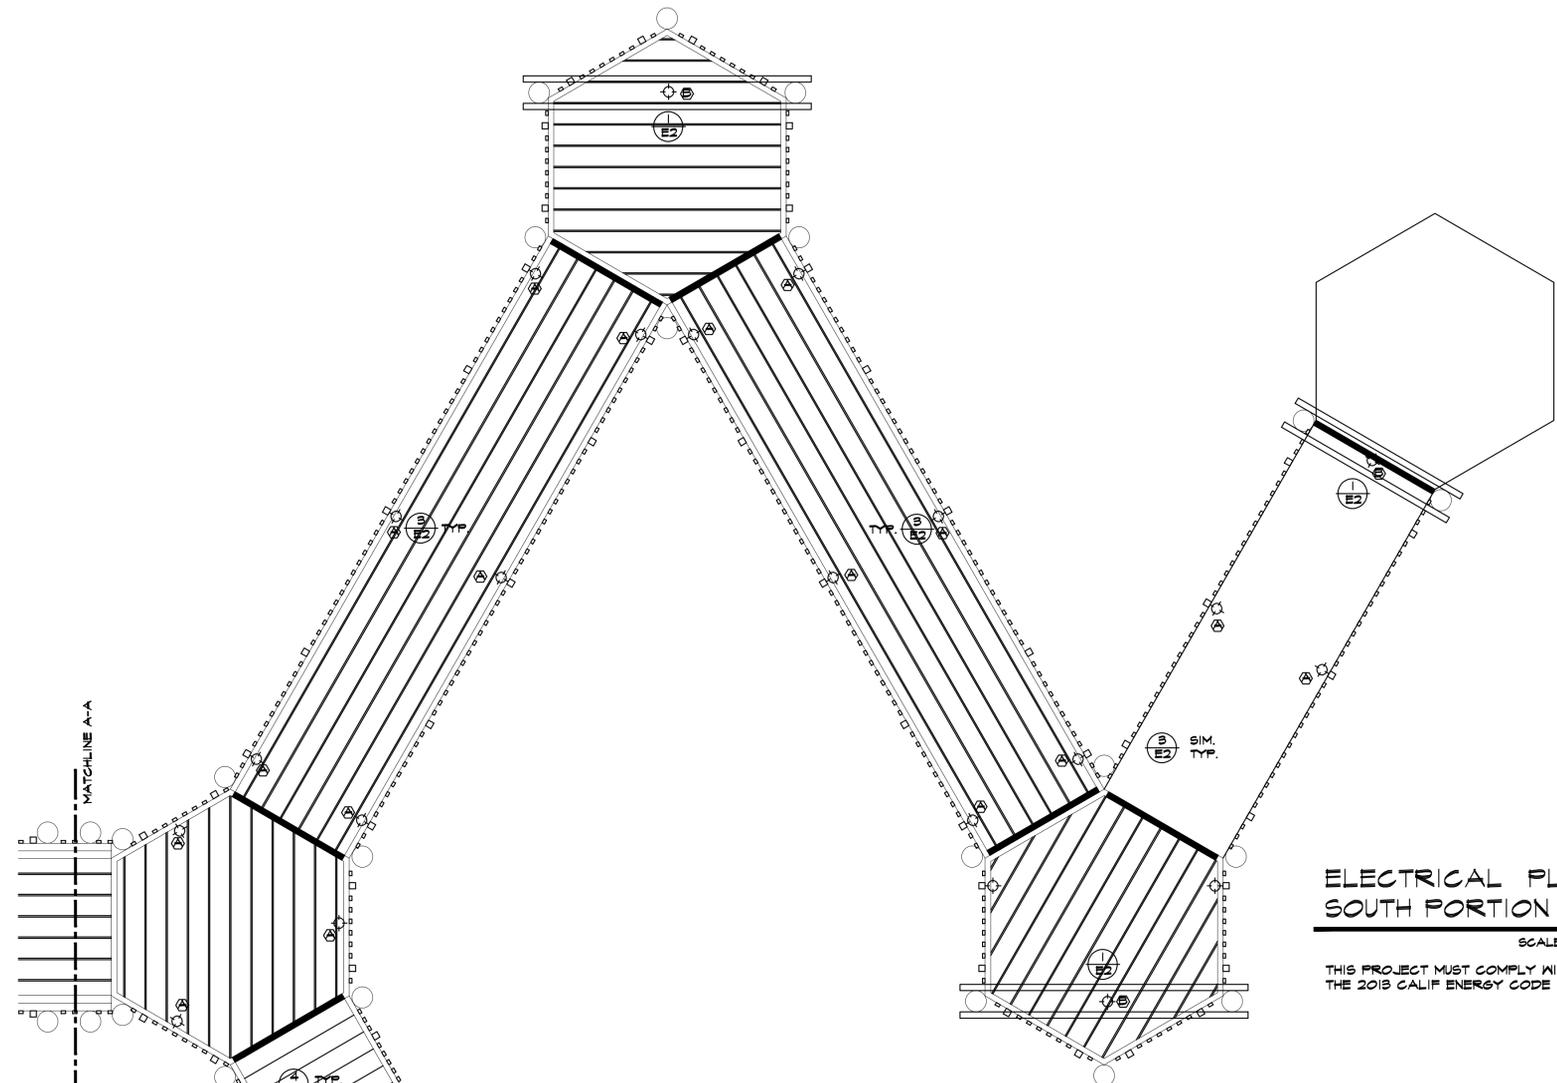
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of 10 shts

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**ELECTRICAL PLANS - SOUTH PORTION**


SCALE 5/16" = 1'-0"

THIS PROJECT MUST COMPLY WITH THE 2013 CALIF ENERGY CODE

LIGHTING FIXTURE SCHEDULE				
TYPE	SYMBOL	DESCRIPTIONS	LAMPS	WATTS/FIXTURE
(A)	☆	KENALL MODEL # H61EL -PP-DB-18Q -I-120 AL- 4500 EYELID FIXTURE	1-18W QUAD FLOURESCENT	18
(B)	☆	KENALL MODEL # H121FL-PP-DB-26Q-I-120-AL-4500	1-26W QUAD FLOURESCENT	26

**GENERAL NOTES:**

01. REMOVE ALL EXTERIOR LIGHTS AND REPLACE WITH NEW WP LIGHTS. VERIFY LOCATION & QUANTITY OF LIGHTING FIXTURES WITH THE ARCHITECT AND IN FIELD. RECONNECT TO EXISTING CIRCUITS AND EQUIPMENT. REPAIR EXISTING CIRCUITS OR ADD NEW CIRCUITS IF REQUIRED. VERIFY EXACT FIELD CONDITIONS.

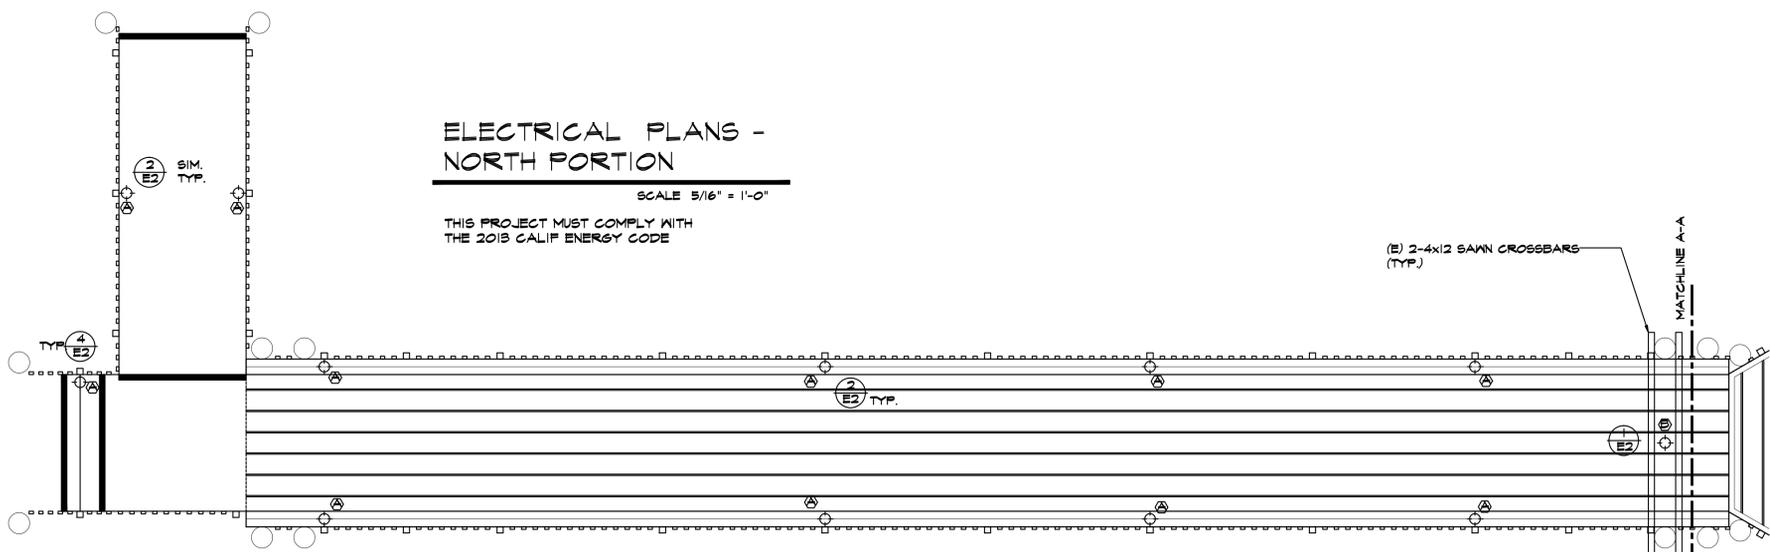

**ELECTRICAL PLANS - NORTH PORTION**

SCALE 5/16" = 1'-0"

THIS PROJECT MUST COMPLY WITH THE 2013 CALIF ENERGY CODE

**PROPOSED ELECTRICAL PLANS**

Renovations to  
Milwood Park  
Pedestrian Bridge  
Saratoga, Ca

for:  
City of Saratoga  
13777 Fruitvale Ave.  
Saratoga, Ca


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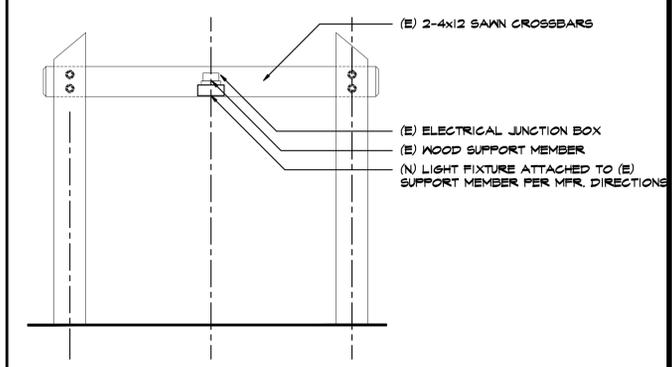
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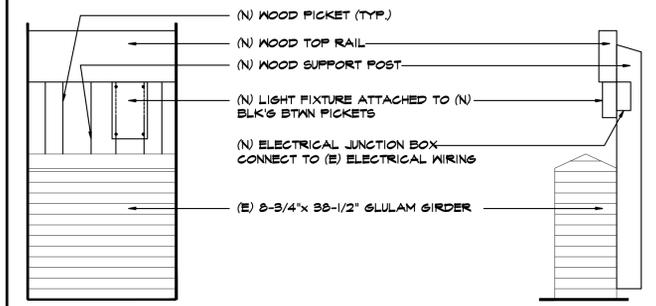
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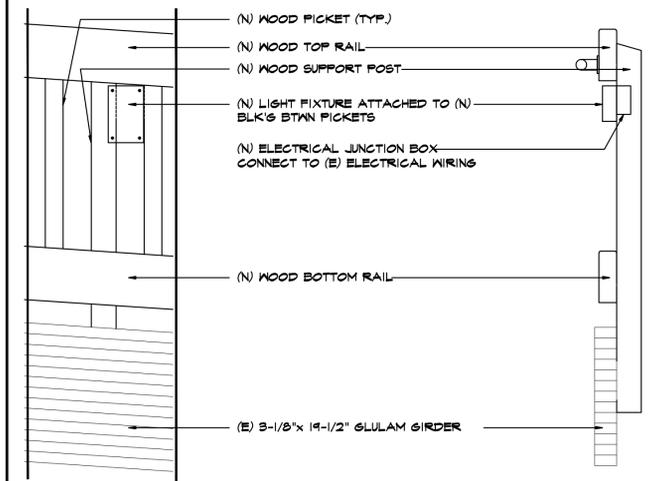
4 STAIR RAILING LIGHT FIXTURE DETAIL N.T.S.



1 FLAT-ARCH LIGHT FIXTURE DETAIL N.T.S.



2 BRIDGE RAILING LIGHT FIXTURE DETAIL N.T.S.

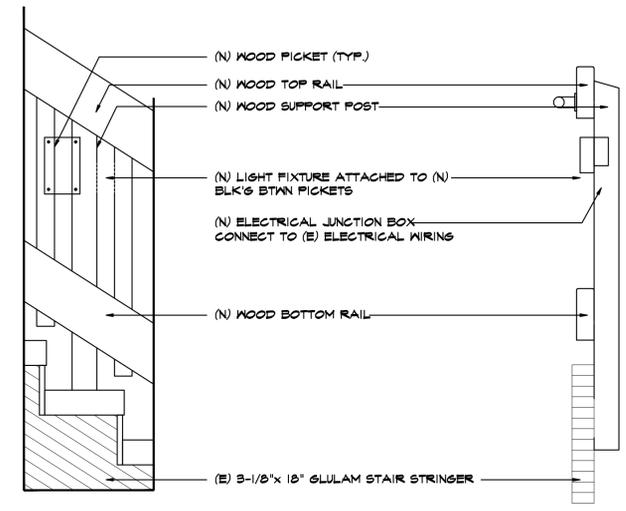

3 RAMP RAILING LIGHT FIXTURE DETAIL N.T.S.

ELECTRICAL DETAILS

Renovations to  
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Saratoga, Ca

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